

PWL Partnership Landscape Architects Inc 5th Floor, East Asiatic House 1201 West Pender Street Vancouver BC Canada V6E 2V2 www.pwlpartnership.com T 604.688.6111 F 604.688.6112



资 POLYGON

_	REVIS	IONS AND ISSUES		
	NO.	DATE	DESCRIPTION	
	2	2019-11-27	ISSUED FOR AUDP	
	3	2020-01-06	DEVELOPMENT PERMIT BOARD SUBMISSION	
	4	2020-02-10	RE-ISSUED FOR DEVELOPMENT PERMIT	
	5	2020-03-01	ISSUED FOR PRICING	
	6	2020-05-29	ISSUED FOR 50% BP	
	7	2020-07-16	ISSUED FOR 90% BP	
	8	2020-10-29	ISSUED FOR DPMA	
	9	2020-10-29	ISSUED FOR TENDER	
	10	2021-01-08	ISSUED FOR BUILDING PERMIT	

PROJECT NAME

UBC LOT 5 WESTBROOK PLACE

CIVIC ADDRESS

5728 Berton Avenue

CLIENT

Polygon

DRAWING CONTENTS

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GRADING PLAN
PLANT LIST
PLANTING PLAN
LIGHTING PLAN
IRRIGATION PLAN
SOIL DEPTH DIAGRAM
DETAILS

THE CONSERVATORY UBC LOT 5 WESBROOK PLACE

5608 Berton Avenue, Vancouver BC

COVER

DRAWING TITLE

PROJECT

ADDRESS

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NORTH		SCALE		
PROJECT NO.	19037			
DATE	November 2	019		
FILE NAME	19037 PLAI	N.vwx		
PLOTTED	21-1-12			
DRAWN	MB, EW	REVIEWED	BH	
DRAWING				

L0.00

LAYOUT AND MATERIALS GENERAL NOTES

- 1. DO NOT SCALE DRAWING. LAYOUT AS PER DIMENSIONS NOTED ON LANDSCAPE PLANS. REPORT ANY DISCREPANCIES TO CONSULTANT FOR REVIEW AND RESPONSE.
- 2. LAYOUT AND MATERIALS DRAWINGS ARE TO BE READ IN CONJUNCTION WITH LANDSCAPE SPECIFICATIONS.
- 3. LANDSCAPE DRAWINGS ARE TO BE READ IN CONJUNCTION WITH ARCHITECTURAL AND ENGINEERING DRAWINGS. REPORT ANY DISCREPANCIES TO CONSULTANT FOR REVIEW AND RESPONSE.
- 4. VERIFY ALL DIMENSIONS WITH FIELD CONDITIONS. REPORT ANY DISCREPANCIES TO CONSULTANT FOR REVIEW AND RESPONSE.
- 5. EXTERIOR LIGHTING SHOWN ON LANDSCAPE PLANS IS FOR REFERENCE ONLY. LIGHTING INFORMATION REFERENCED ON LANDSCAPE DRAWINGS IS TO BE READ IN CONJUNCTION WITH ELECTRICAL ENGINEER'S DRAWINGS.
- 6. REFERENCE CIVIL ENGINEER'S DRAWINGS FOR LAYOUT OF ROAD CURBS AND GUTTERS.

GRADING GENERAL NOTES

- 1. REFER TO ARCHITECTURAL PLANS, SECTIONS AND ELEVATIONS FOR TOP OF SLAB ELEVATIONS. SLAB ELEVATIONS INDICATED ON LANDSCAPE DRAWINGS ARE FOR REFERENCE ONLY. REPORT ANY DISCREPANCIES TO CONSULTANT FOR REVIEW AND RESPONSE.
- 2. CONFIRM ALL EXISTING GRADES PRIOR TO CONSTRUCTION. REPORT ANY DISCREPANCIES TO CONSULTANT FOR REVIEW AND RESPONSE.
- 3. GROWING MEDIUM DEPTHS ON ARCHITECTURAL SLAB ARE NOT TO EXCEED THOSE SPECIFIED IN SPECIFICATIONS. REPORT ANY DISCREPANCIES TO CONSULTANT FOR REVIEW AND RESPONSE.
- 4. SLAB DRAINS AND PLANTER SLAB DRAINS ARE SHOWN FOR REFERENCE ONLY AND ARE TO BE READ IN CONJUNCTION WITH MECHANICAL ENGINEERING DRAWINGS. REPORT ANY DISCREPANCIES TO CONSULTANT FOR REVIEW AND RESPONSE.
- 5. UNLESS OTHERWISE NOTED ALL DRAINS LOCATED IN LAWN OR PLANTED AREAS TO BE COMPLETE WITH INSPECTION CHAMBER AND CLEANOUT AS DETAILED ON LANDSCAPE DRAWINGS.
- 6. UNLESS OTHERWISE NOTED PROVIDE A MINIMUM SLOPE OF 2% ON ALL HARD AND SOFT LANDSCAPE AREAS TO ENSURE POSITIVE DRAINAGE AWAY FROM BUILDINGS OR TO DRAINAGE STRUCTURES.
- 7. UNLESS OTHERWISE NOTED MAXIMUM SLOPE OF SOFT LANDSCAPE AREAS TO BE 3:1 (33%). REPORT ANY DISCREPANCIES TO CONSULTANT FOR REVIEW AND RESPONSE.
- 8. UNLESS OTHERWISE NOTED PROVIDE A MAXIMUM SLOPE OF 5% ON ALL HARD LANDSCAPE AREAS. REPORT ANY DISCREPANCIES TO CONSULTANT FOR REVIEW AND RESPONSE.
- 9. TOP OF CURB ELEVATIONS ARE SHOWN FOR REFERENCE ONLY. REFER TO CIVIL DRAWINGS FOR CURB ELEVATIONS.
- 10. TIE INTO EXISTING ELEVATIONS AT EXTENT OF WORK CLEAN AND FLUSH. REPORT ANY DISCREPANCIES TO CONSULTANT FOR REVIEW AND RESPONSE.

SITE FURNISHING MATERIALS LEGEND				
KEY	DETAIL	DESCRIPTION		
F1	5, 6 L6.05	FURNISHING TYPE: BIKE RACK MANUFACTURER: URBAN RACKS PRODUCT NAME : URBAN STAPLE (MODEL: UB-1000-STD) SIZE: 24" x 34" x 4.5" COLOUR AND FINISH : MATERIAL: STAINLESS STEEL / COLOUR: AS PER UBS STD. / FINISH: AS PER UBS STD. / STENCILE NAME: AS PER UBC STD. COMMENT: TO BE SURFACE EMBEDDED, REFER TO MANUFACTURERS SPECIFICATIONS		
F2	3 L6.06	FURNISHING TYPE: BENCH MANUFACTURER: LANDSCAPEFORMS (604.738.0455) PRODUCT NAME : BACKED HARPO BENCH WITH WIDE WOOD SLATS SIZE: 23" x 69" x 31" COLOUR AND FINISH : METAL - COLOUR: DARK GREY / FINISH: POWDERCOATED, WOOD - MATERIAL: DSTMA / FINISH: NA COMMENT: TO BE SURFACE MOUNTED, REFER TO MANUFACTURERS SPECIFICATIONS		
F3	2 L6.06	FURNISHING TYPE: LOUNGE CHAIR MANUFACTURER: LANDSCAPEFORMS (604.738.0455) PRODUCT NAME : HARPO LOUNGE CHAIR SIZE: 32.25" x 24.5" x 35.5" COLOUR AND FINISH : METAL - COLOUR: DARK GREY / FINISH: POWDERCOATED, WOOD - MATERIAL: DSTMA / FINISH: NA COMMENT: TO BE SURFACE MOUNTED, REFER TO MANUFACTURERS SPECIFICATIONS		
F4	1 L6.06	FURNISHING TYPE: CHAISE LOUNGE MANUFACTURER: LANDSCAPEFORMS (604.738.0455) PRODUCT NAME : HARPO CHAISE LOUNGE SIZE: 59.5" x 24.5" x 37.5" COLOUR AND FINISH : METAL - COLOUR: DARK GREY / FINISH: POWDERCOATED, WOOD - MATERIAL: DSTMA / FINISH: NA COMMENT: TO BE SURFACE MOUNTED, REFER TO MANUFACTURERS SPECIFICATIONS		
F5	2 L6.03	FURNISHING TYPE: GATE MANUFACTURER: N/A PRODUCT NAME : N/A SIZE: REFER TO PLANS AND DETAILS COLOUR AND FINISH : MATERIAL: ALUMINUM / COLOUR: POWDERCOAT BLACK / FINISH: N/A COMMENT: CONTRACTOR TO SUBMIT ENGINEERED SHOP DRAWINGS FOR SONSULTANT REVIEW		
F6	5 L6.06	FURNISHING TYPE: CO-WORK STOOL MANUFACTURER: LANDSCAPEFORMS (604.738.0455) PRODUCT NAME: CHIPMAN STOOL SIZE: 19" x 22" x 35" COLOUR AND FINISH: COLOUR: DARK GREY / FINISH: POWDERCOATED COMMENT: TO BE MOVABLE		
F7	4 L6.06	FURNISHING TYPE: CO-WORK TABLE MANUFACTURER: LANDSCAPEFORMS (604.738.0455) PRODUCT NAME : GO OUTDOOR TABLE SIZE: 30" x 114" x 40.5" COLOUR AND FINISH : COLOUR: DARK GREY / FINISH: POWDERCOATED COMMENT: TO BE SURFACE MOUNTED, REFER TO MANUFACTURERS SPECIFICATIONS		
F8	5 L6.07	FURNISHING TYPE: BASALT NATURAL STONE SEAT TYPE 1 MANUFACTURER: NORTHWEST LANDSCAPE SUPPLY (604.435.4842) PRODUCT NAME : NATURAL BASALT BOULDER SIZE: REFER TO PLANS COLOUR AND FINISH : COLOUR: NATURAL / FINISH: SMOOTH/FLAT TOP WITH NATURAL TUMBLED SIDES AND ROUNDED EDGES COMMENT: CONSULTANT TO SELECT FROM STONE YARD AND OVERSEE PLACEMENT ON SITE		
F9	5 L6.07	FURNISHING TYPE: BASALT NATURAL STONE SEAT TYPE 2 MANUFACTURER: NORTHWEST LANDSCAPE SUPPLY (604.435.4842) PRODUCT NAME : NATURAL BASALT BOULDER SIZE: 1'6" x 1'6" x 6'0" (MULTIPLE PIECES ACCEPTABLE) COLOUR AND FINISH : COLOUR: NATURAL / FINISH: SAWN AND POLISHED TOP WITH NATURAL SPLIT/TUMBLED SIDES COMMENT: CONSULTANT TO SELECT FROM STONE YARD. CONTRACTOR TO BUILD MOCK-UP AND SUBMIT IMAGES FOR CONSULTANT REVIEW.		

KEY	DETAIL	DESCRIPTION
P1	1, 2 L6.01	 PAVING TYPE: UNIT PAVER TYPE 1 - RUNNING BOND MANUFACTURER: BARKMAN CONCRETE LTD. (778.689.7670) PRODUCT NAME: BROADWAY 65mm PAVER SIZE: 23.62" x 11.81" x 2.56" (600mm x 300mm x 65mm) COLOUR/FINISH: COLOUR: NATURAL / FINISH: NA / PATTERN: RUNNING BOND COMMENT: CONTRACTOR TO SUBMIT SAMPLE AND CUT SHEETS FOR CONSULTANT'S REVIEW
P2	5 L6.01	PAVING TYPE: UNIT PAVER TYPE 1 - STAGGERED LAYOUT MANUFACTURER: BARKMAN CONCRETE LTD. (778.689.7670) PRODUCT NAME: BROADWAY 65mm PAVER SIZE: 23.62" x 11.81" x 2.56" (600mm x 300mm x 65mm) COLOUR/FINISH: COLOUR: NATURAL / FINISH: NA / PATTERN: STAGGERED OFFSET LAYOUT COMMENT: CONTRACTOR TO SUBMIT SAMPLE AND CUT SHEETS FOR CONSULTANT'S REVIEW
P3	(1, 2) L6.01	 PAVING TYPE: UNIT PAVER TYPE 2 MANUFACTURER: BARKMAN CONCRETE LTD. (778.689.7670) PRODUCT NAME: BROADWAY 65mm PAVER SIZE: 11.81" x 5.9" x 2.56" (300mm x 150mm x 65mm) COLOUR/FINISH: COLOUR: ASH / FINISH: NA / PATTERN: RUNNING BOND COMMENT: CONTRACTOR TO SUBMIT SAMPLE AND CUT SHEETS FOR CONSULTANT'S REVIEW
P4	3 L6.01	PAVING TYPE: HYDRAPRESSED PAVER MANUFACTURER: ABBOTSFORD CONCRETE PRODUCTS (1.800.663.4091 PRODUCT NAME: TEXADA HYDRAPRESSED SLABS SIZE: 18" x 18" x 1-5/8" (457mm x 457mm x 41mm) COLOUR/FINISH: COLOUR: NATURAL/ FINISH: SHOTBLAST COMMENT: CONTRACTOR TO SUBMIT SAMPLE AND CUT SHEETS FOR CONSULTANT'S REVIEW
P5	7 L6.01	 PAVING TYPE: MAINTENANCE STRIP MANUFACTURER: NORTHWEST LANDSCAPE AND STONE SUPPLY (604.435.4842) PRODUCT NAME: RIVER ROCK SIZE: 2" - 6" (50mm - 150mm) COLOUR/FINISH: COLOUR: NA / FINISH: NA COMMENT: CONTRACTOR TO SUBMIT SAMPLE AND CUT SHEETS FOR CONSULTANT'S REVIEW
P6	4 L6.01	PAVING TYPE: CIP CONCRETE MANUFACTURER: CONTRACTOR PRODUCT NAME: N/A SIZE: REFER TO PLANS AND DETAILS COLOUR/FINISH: COLOUR: NATURAL / FINISH: LIGHT SANDBLAST COMMENT: CONTRACTOR TO SUBMIT SAMPLE AND CUT SHEETS FOR CONSULTANT'S REVIEW
P7	4 L6.05	PAVING TYPE: TACTILE WARNING STRIP MANUFACTURER: CONTRACTOR PRODUCT NAME: N/A SIZE: REFER TO PLANS AND DETAILS COLOUR/FINISH: COLOUR: NATURAL / FINISH: TOOLED, MEDIUM BROO FINISH COMMENT: REFER TO DETAILS
P8	1 L6.07	 PAVING TYPE: NATURAL FLAGSTONE PAVER MANUFACTURER: NORTHWEST LANDSCAPE SUPPLY (604.435.4842) PRODUCT NAME: BASALT STEPPING STONE WITH BASALT CLEAR CRUSHED GRANULAR 3/4" JOINTING SIZE: REFER TO PLANS AND DETAILS COLOUR/FINISH: COLOUR: NATURAL / FINISH: TUMBLED COMMENT: CONSULTANT TO SELECT EACH STEPPING PAD FROM STON YARD. CONTRACTOR TO BUILD MOCK-UP AND SUBMIT IMAGES FOR CONSULTANT REVIEW.
P9	1, 2 L6.07	PAVING TYPE: CRUSHED GRANULAR WITHOUT EDGER MANUFACTURER: NORTHWEST LANDSCAPE SUPPLY (604.435.4842) PRODUCT NAME: BASALT CLEAR CRUSHED GRANULAR 3/4" SIZE: REFER TO PLANS AND DETAILS COLOUR/FINISH: COLOUR: NATURAL / FINISH: NA COMMENT: CONTRACTOR TO SUBMIT SAMPLE AND CUT SHEETS FOR


HARDSCAPE MATERIALS LEGEND

HARD	SCAPE N	MATERIALS LEGEND
KEY	DETAIL	DESCRIPTION
HI	2 L6.02	 HARDSCAPE TYPE: ONE SIDED - CIP CONCRETE WALL WITH STONE CLADDING SUPPLIER: K2 STONE (866.722.2420) DESCRIPTION: PACIFIC ASHLAR FULL BED SIZE: REFER TO PLANS AND DETAILS FINISH: COLOUR: BLUE/SLATE GREY WITH OCCASIONAL QUARTZ VEINS / FINISH: SPLIT NATURAL FACE / PATTERN: OFFSET RUNNING BOND - REFER TO DETAILS COMMENT: CONTRACTOR TO SUBIT SAMPLE AND CUT SHEET FOR CONSULTANT REVIEW
(H2)	1 L6.02	HARDSCAPE TYPE: DOUBLE SIDED - CIP CONCRETE WALL WITH STONE CLADDING SUPPLIER: K2 STONE (866.722.2420) DESCRIPTION: PACIFIC ASHLAR FULL BED SIZE: REFER TO PLANS AND DETAILS FINISH: COLOUR: BLUE/SLATE GREY WITH OCCASIONAL QUARTZ VEINS / FINISH: SPLIT NATURAL FACE / PATTERN: OFFSET RUNNING BOND - REFER TO DETAILS COMMENT: CONTRACTOR TO SUBIT SAMPLE AND CUT SHEET FOR CONSULTANT REVIEW
H3	1 L6.03	HARDSCAPE TYPE: ENTRY PLINTH - CIP CONC. STONE CLAD WALL SUPPLIER: K2 STONE (866.722.2420) DESCRIPTION: PACIFIC ASHLAR FULL BED SIZE: REFER TO PLANS AND DETAILS FINISH: COLOUR: BLUE/SLATE GREY WITH OCCASIONAL QUARTZ VEINS / FINISH: SPLIT NATURAL FACE / PATTERN: OFFSET RUNNING BOND - REFER TO DETAILS COMMENT: CONTRACTOR TO SUBIT SAMPLE AND CUT SHEET FOR CONSULTANT REVIEW
H4	1 - 4 L6.05	HARDSCAPE TYPE: CONCRETE STAIRS SUPPLIER: CONTRACTOR DESCRIPTION: CAST IN PLACE SIZE: REFER TO PLANS AND DETAILS FINISH: COLOUR: NATURAL / FINISH: ARCHITECTURAL COMMENT: REFER TO GRADING PLANS AND DETAILS
(H4a)	1 - 4 L6.05	HARDSCAPE TYPE: CONCRETE STAIRS WITH HANDRAIL SUPPLIER: CONTRACTOR DESCRIPTION: CAST IN PLACE SIZE: REFER TO PLANS AND DETAILS FINISH: COLOUR: NATURAL / FINISH: ARCHITECTURAL COMMENT: REFER TO GRADING PLANS AND DETAILS
H5	8 L6.01	HARDSCAPE TYPE: CONCRETE WALL SUPPLIER: CONTRACTOR DESCRIPTION: CAST IN PLACE SIZE: REFER TO PLANS AND DETAILS FINISH: COLOUR: NATURAL / FINISH: ARCHITECTURAL COMMENT: REFER TO GRADING PLANS AND DETAILS
He	7 L6.01	HARDSCAPE TYPE: TIMBER WALL SUPPLIER: CONTRACTOR DESCRIPTION: 4 x 6 ACQ PT TIMBER SIZE: REFER TO PLANS AND DETAILS FINISH: COLOUR: NA / FINISH: NA COMMENT: REFER TO GRADING PLANS AND DETAILS
H7	1 L6.04	HARDSCAPE TYPE: METAL RETAINING WALL SUPPLIER: CONTRACTOR DESCRIPTION: POWDERCOATED STAINLESS STEEL SIZE: REFER TO PLANS AND DETAILS FINISH: COLOUR: RAL 7039 / FINISH: ALL EDGES TO BE EASED COMMENT: CONTRACTOR TO SUBMIT ENGINEERED SHOP DRAWINGS FOR CONSULTANT REVIEW
HB	3 L6.02	HARDSCAPE TYPE: MODULAR BLOCK RETAINING WALL SUPPLIER: ALLAN BLOCK DESCRIPTION: AB CLASSIC, AB CAPS SIZE: REFER TO PLANS AND DETAILS FINISH: COLOUR: GREY / FINISH: NA COMMENT: REFER TO GRADING PLANS AND DETAILS
H9	3 L6.03	HARDSCAPE TYPE: GUARD RAIL SUPPLIER: CONTRACTOR DESCRIPTION: METAL GUARD RAIL SIZE: REFER TO PLANS AND DETAILS FINISH: MATERIAL: ALUMINUM / COLOUR: POWDERCOAT BLACK / FINISH: N/A COMMENT: REFER TO GRADING PLANS AND DETAILS
(H10)	2 L6.04	HARDSCAPE TYPE: GAS METRE ENCLOSURE SUPPLIER: CONTRACTOR DESCRIPTION: METAL ENCLOSURE SIZE: REFER TO PLANS AND DETAILS FINISH: MATERIAL: ALUMINUM / COLOUR: POWDERCOAT BLACK / FINISH: N/A COMMENT: REFER TO GRADING PLANS AND DETAILS
(H11)	3, 4 L6.07	HARDSCAPE TYPE: NATURAL BASALT BOULDER SUPPLIER: NORTHWEST LANDSCAPE SUPPLY (604.435.4842) DESCRIPTION: NATURAL BASALT BOULDER SET INTO MOUND SIZE: REFER TO PLANS AND DETAILS FINISH: COLOUR: NATURAL / FINISH: NATURAL TUMBLED / ROUNDED COMMENT: CONSULTANT TO SELECT FROM STONE YARD AND OVERSEE PLACEMENT ON SITE

	N
	PWL Partnership Landscape Architects In 5th Floor, East Asiatic House 1201 West Pender Street Vancouver BC Canada V6E 2V2 www.pwlpartnership.com
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dy	s architecture
	70 Burrard Street Vancouver BC V6J 3G7 669 7710 www.dysarchitecture.com
P	OLYGON
REVISIONS AND ISSUES NO. DATE 2 2019-11-27 3 2020-01-06	DESCRIPTION ISSUED FOR AUDP DEVELOPMENT PERMIT BOARD SUBMISSION
4 2020-02-10 5 2020-03-01 6 2020-05-29 7 2020-07-16	RE-ISSUED FOR DEVELOPMENT PERMIT ISSUED FOR PRICING ISSUED FOR 50% BP ISSUED FOR 90% BP
8 2020-10-29 9 2020-10-29 10 2021-01-08	ISSUED FOR DPMA ISSUED FOR TENDER ISSUED FOR BUILDING PERMIT
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THE COUBC LO	OT 5
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PROJECT NO.	19037			
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PACIFIC SPIRI **REGIONAL PAR**

dys architecture 260 - 1770 Burrard Street Vancouver BC V6J 3G7 tel 604 669 7710 www.dysarchitecture.com

POLYGON
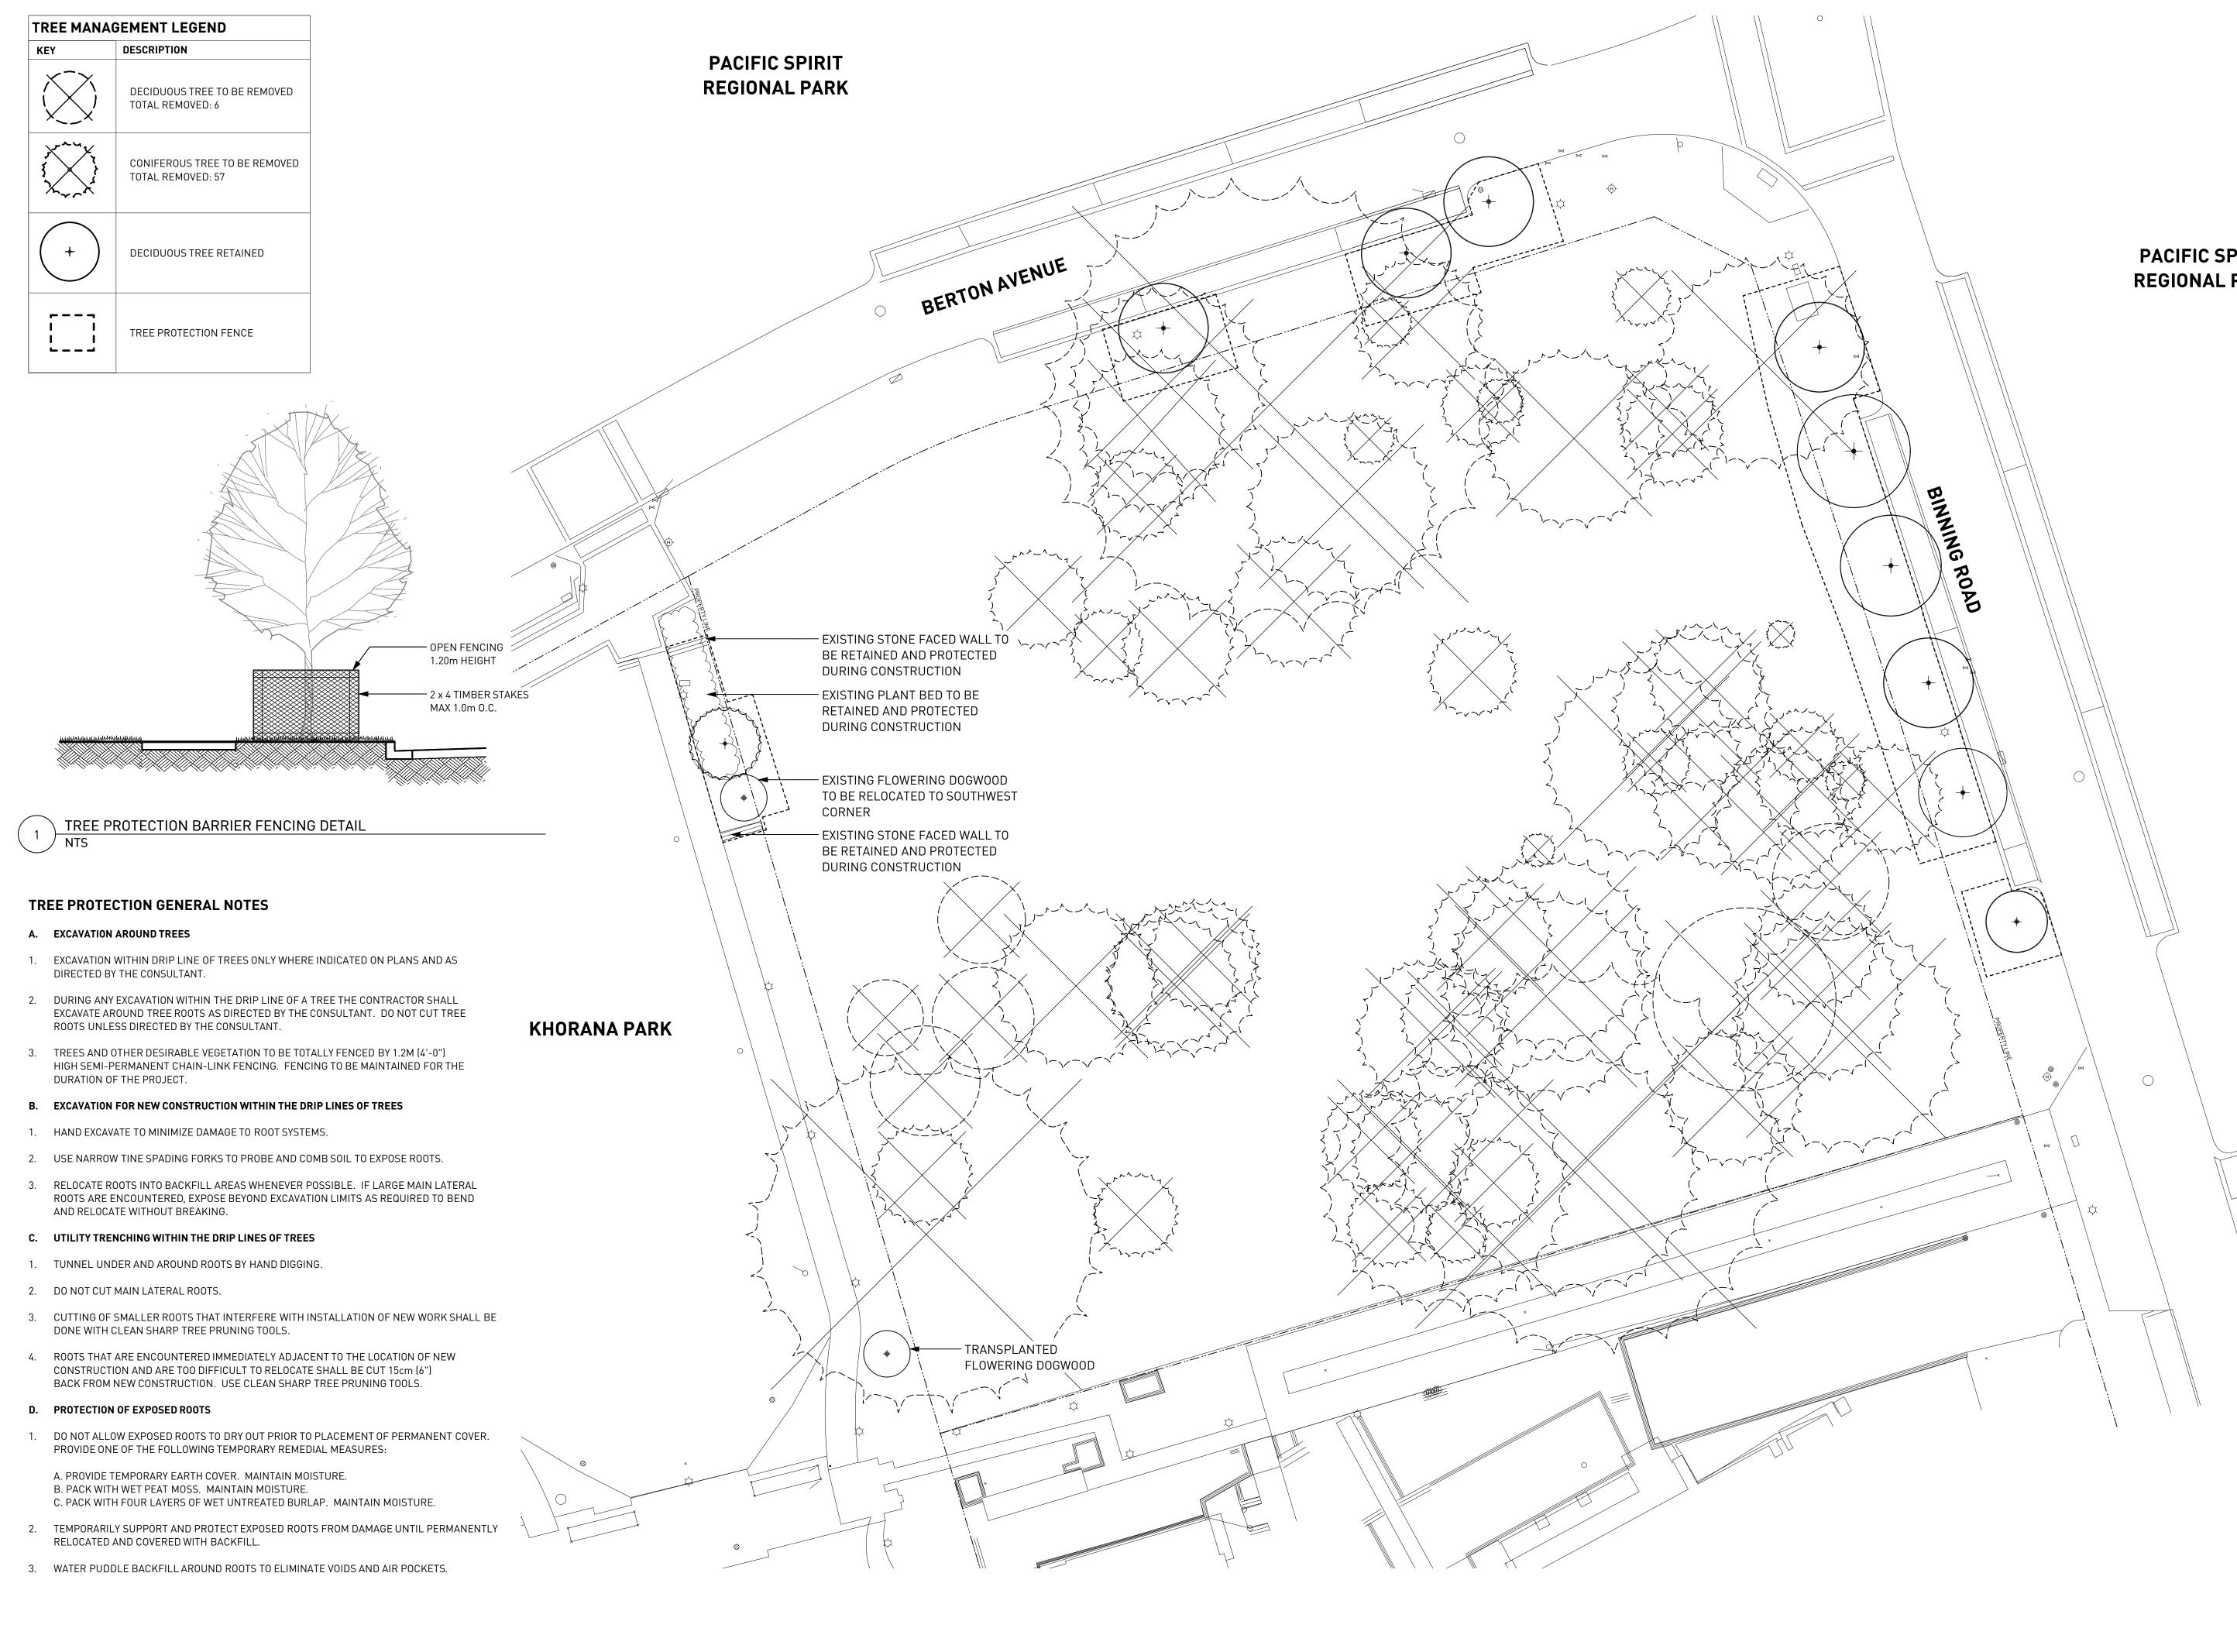
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	10	2021-01-08	ISSUED FOR BUILDING PERMIT

PROJECT THE CONSERVATORY UBC LOT 5 WESBROOK PLACE

5608 Berton Avenue, Vancouver BC


ADDRESS

DRAWING TITLE

TREE MANAGEMENT PLAN

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L0.02

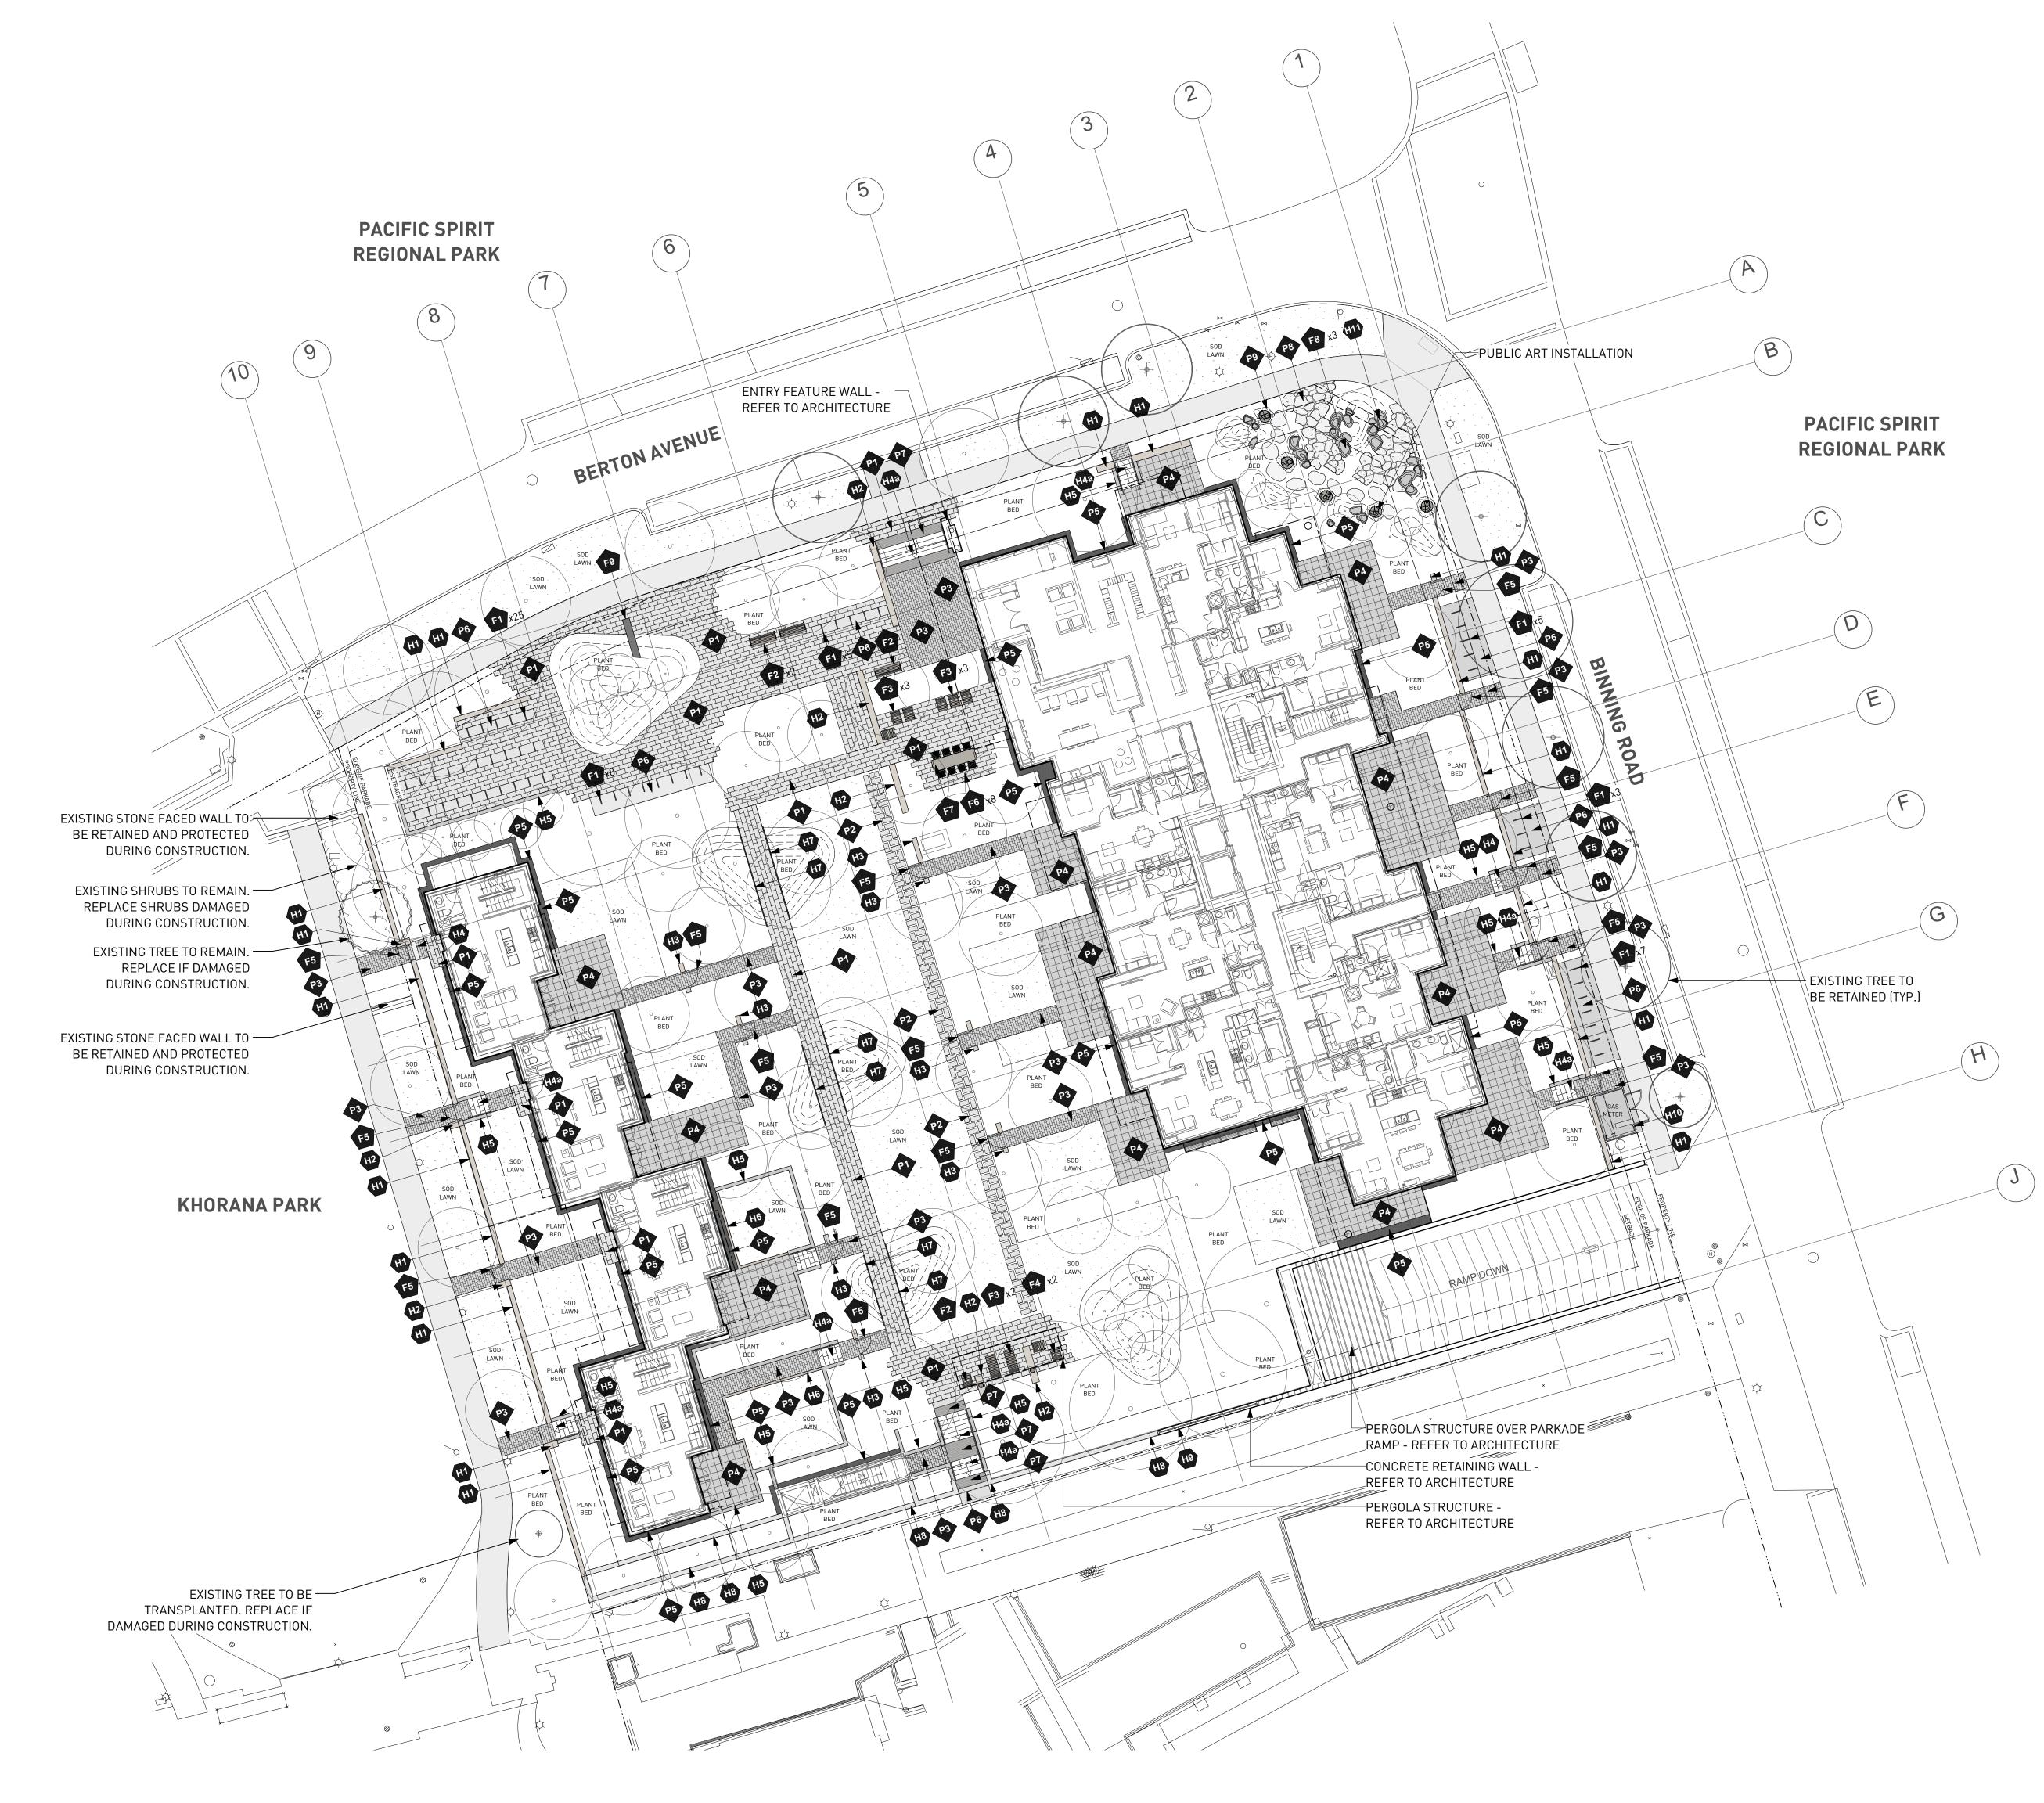

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260 - 1770 Burrard Street Vancouver BC V6J 3G7 tel 604 669 7710 www.dysarchitecture.com

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	5 5 7 8	2 2019-11-27 3 2020-01-06 4 2020-02-10 5 2020-03-01 5 2020-05-29 7 2020-07-16 8 2020-10-29 9 2020-10-29		

THE CONSERVATORY UBC LOT 5 WESBROOK PLACE

5608 Berton Avenue, Vancouver BC

ADDRESS

DRAWING TITLE

LAYOUT AND MATERIALS PLAN

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 NORTH
 SCALE

 I/16"=1'0"

 PROJECT NO.
 19037

 DATE
 November 2019

 FILE NAME
 19037 PLAN.vwx

 PLOTTED
 21-1-12

 DRAWIN
 MB, EW
 REVIEWED
 BH

L1.01

GRADING GENERAL NOTES

- 1. REFER TO ARCHITECTURAL PLANS, SECTIONS AND ELEVATIONS FOR TOP OF SLAB ELEVATIONS. SLAB ELEVATIONS INDICATED ON LANDSCAPE DRAWINGS ARE FOR REFERENCE ONLY. REPORT ANY DISCREPANCIES TO CONSULTANT FOR REVIEW AND RESPONSE.
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GRADING LEGEND			
ft 0.00.			
+ EL 0.94'	Existing Elevation		
FFE 0.94'	Proposed Elevation		
+	Finished Floor Elevation		
TW 0.94'	Proposed Top of Wall Elevation		
BW 0.94'	Proposed Bottom of Wall Elevation		
<u>TS 0.94'</u>	Proposed Top of Stair Elevation		
BS 0.94'	Proposed Bottom of Stair Elevation		
TC 0.94'	Proposed Top of Curb Elevation		
BC 0.94'	Proposed Bottom of Curb Elevation		
TR 0.94'	Proposed Top of Ramp Elevation		
BR 0.94'	Proposed Bottom of Ramp Elevation		
<u>SW 0.94'</u>	Swale Elevation		
79.5	Existing Contour		
79.5	Proposed Contour		
Т	Trench Drain		
P	Perforated Pipe		
AD Ø	Area Drain		
LB O	Lawn Basin		
PD Ø	Planter Drain		
CB Ø	Catch Basin		
RD	Roof Drain, shown for reference only, see mechanical and architectural drawings		
	RM DRAIN LOCATIONS WITH MECHANICAL, CH DRAWINGS. REPORT ANY DISCREPANCIES.		

PACIFIC SPIRIT REGIONAL PARK


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<u>(</u>9)

(10)

KHORANA PARK



PWL partnership
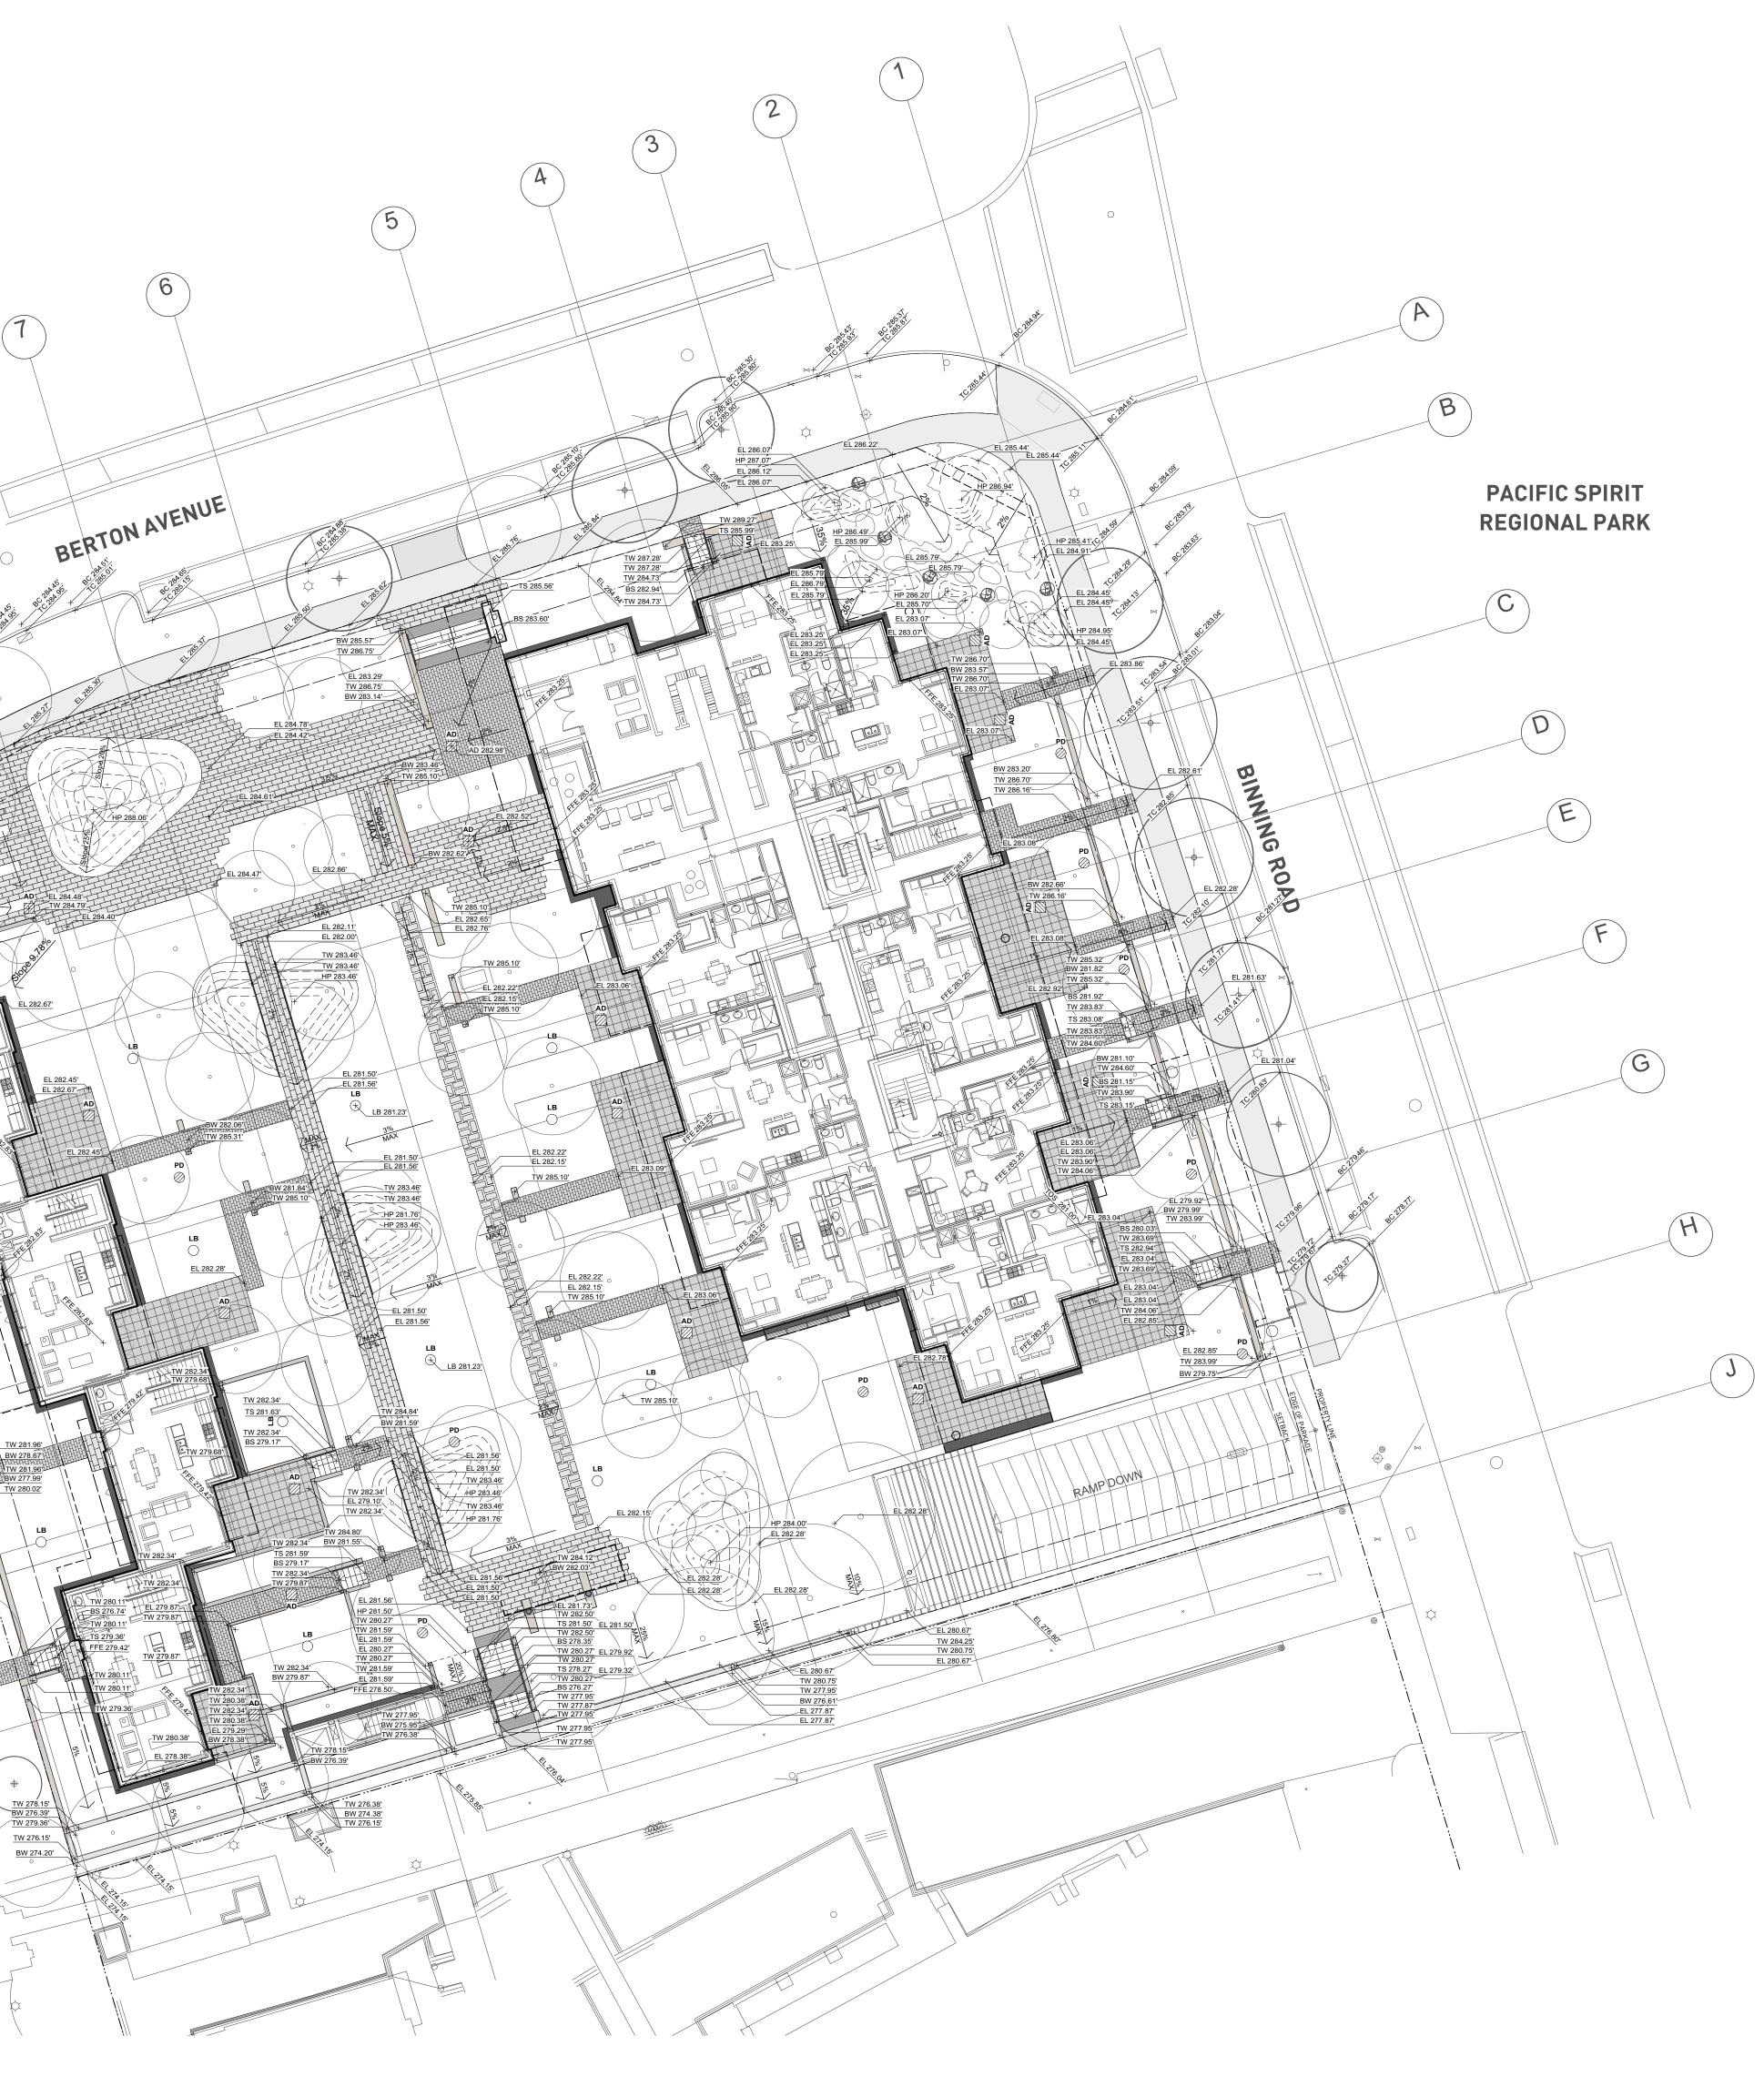
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GRADING PLAN

Copyright. All rights reserved. Reproduction in whole or in part is prohibited. This drawing as an instrument of service is the property of the Consultant and may not be used in any way without the written permission of this office SCALE 1/16"=1'0" PROJECT NO. 19037 DATE November 2019 19037 PLAN.vwx FILE NAME 21-1-12 PLOTTED MB, EW REVIEWED DRAWN BH DRAWING

L2.01

PLANTING GENERAL NOTES

- 1. ALL PLANTS ARE TO CONFORM TO THE STANDARD SPECIFIED IN THE LATEST EDITION OF THE BC LANDSCAPE STANDARD. THE STANDARD IS PUBLISHED BY THE BC SOCIETY OF LANDSCAPE ARCHITECTS AND BC LANDSCAPE AND NURSERY ASSOCIATION.
- 2. SEARCH AREA FOR PLANT MATERIAL IS TO INCLUDE ALL OF WESTERN NORTH AMERICA.
- 3. PLANT MATERIAL SIZES SPECIFIED IN THE PLANT LIST ARE THE MINIMUM ACCEPTABLE SIZES FOR MATERIAL SUPPLIED FOR THIS PROJECT.
- 4. PLANTS WILL BE WELL ESTABLISHED AND UNIFORM IN SHAPE.
- 5. PLANTS WILL BE NUSERY GROWN UNLESS NOTED OTHERWISE.
- 6. THE CONTRACTOR SHALL PROVIDE A GROWING MEDIUM ANALYSIS FOR REVIEW BY THE CONSULTANT AS PER SPECIFICATIONS PRIOR TO THE START OF CONSTRUCTION. GROWING MEDIUM SUPPLIED TO THE SITE OR PLACED ON SITE PRIOR TO REVIEW BY THE CONSULTANT WILL BE REJECTED.
- CONTRACTOR TO CONFIRM PLANT QUANTITIES ON DRAWING CORRESPOND TO THOSE INDICATED ON THE PLANT LIST. REPORT ANY DISCREPANCIES TO CONSULTANT FOR REVIEW AND RESPONSE.
- 8. PLANT LIST IS TO BE READ IN CONJUNCTION WITH SPECIFICATIONS.
- PRIOR TO THE START OF CONSTRUCTION THE CONTRACTOR IS TO CONFIRM THE AVAILABILITY OF PLANT MATERIAL AS PER SPECIFICATIONS. PLANT SUBSTITUTIONS NOT CONFIRMED WITH THE CONSULTANT WILL BE REJECTED.

Plant List
The Conservatory

ID	Qty	Botanical Name	Common Name	Scheduled Size	Spacing
		Trees			
ACR	3	Acer circinatum	Vine Maple	3.0 m ht. (8'-0" ht.)	As Shown
AFJ	15	Acer x freemanii 'Jeffersred'	Autumn Blaze Maple	8 cm cal. (3" cal.)	As Shown
AXA	4	Amelanchier x grandiflora 'Autumn Brillance'	Autumn Brilliance Serviceberry	6 cm cal. (1 1/2" cal.)	As Shown
CCD	9	Cercis canadensis 'Appalachian Red'	Appalachian Red Eastern Redbud	#10 pot (8'-0" ht.)	As Shown
СКО	15	Cornus kousa	Kousa Dogwood	6 cm cal. (2" cal.)	As Shown
MGP	3	Metasequoia glyptostroboides	Dawn Redwood	5cm cal. (8'-0" ht.)	As Shown
PPI	7	Parrotia persica 'Inge's Ruby Vase'	'IRV' Persian Ironwood	6 cm cal. (2" cal.)	As Shown
POR-3	11	Picea omorika	Serbian Spruce	2.0 m ht. (6'-0" ht.)	As Shown
POR-2	8	Picea omorika	Serbian Spruce	2.4 m ht. (10'-0" ht.	As Shown
POR-1	7	Picea omorika	Serbian Spruce	3.0 m ht. (10'-0" ht.)	As Shown
PTR	6	Populus tremuloides	Quaking Aspen	5 cm cal. (2" cal.)	As Shown
SPS	12	Stewartia pseudocamellia	Japanese Stewartia	6 cm cal. (2" cal.)	As Shown
		Shrubs			
AUC	26	Arbutus unedo 'Compacta'	Compact Strawberry Tree	#3 pot	90cm (36")
BMW	67	Buxus microphylla 'Winter Gem'	Winter Gem Boxwood	#3 pot	38cm (15")
000	83	Ceanothus impressus 'Victoria'	Brilliant Ceanothus	#3 pot	90cm (36")
CTR	47	Choisya ternata	Mexican Orange Blossom	#3 pot	90cm (36")
CAS	19	Cornus alba 'Sibirica'	Siberian Dogwood	#2 pot	90cm (36")
CSK	13	Cornus sericea 'Kelseyii'	Kelseyii Dogwood	#2 pot	60cm (24")
DBW	106	Daphne burkwoodii ' Carol Mackie'	Carol Mackie Daphne	#3 pot	38cm (15")
EHN	118	Escallonia 'Newport Dwarf'	Newport Dwarf Escallonia	#3 pot	60cm (24")
GSH	26	Gaultheria shallon	Salal	#2 pot	45cm (18")
HYR	24	Hibiscus syriacus 'Red Heart'	Red Heart Rose-of-Sharon	#3 pot	100cm (39")
NDG	126	Nandina domestica 'Gulf Stream'	Compact Heavenly Bamboo	#3 pot	68cm [27"]
PMP	14	Pinus mugo 'Pumilio'	Dwarf Mugo Pine	#2 pot	110cm (42")
PLO	370	Prunus laurocerasus 'Otto Luyken'	Otto Luyken laurel	#3 pot	60cm (24")
RBB	68	Rhododendron 'Blue Bells'	Bow Bells Rhododendron	#3 pot	75cm (30")
REL	48	Rhododendron 'Elizabeth'	Elizabeth Rhododendron	#3 pot	75cm (30")
RCP	10	Rhododendron carolinianom 'P.J.M.'	P.J.M. Rhododendron	#3 pot	75cm (30")
RSA	10	Ribes sanguineum	Flowering Currant	#3 pot	75 cm (30")
RMP	186	Rosa 'Meidiland Pink'	Meidiland Pink Rose	#2 pot	60cm (24")
SHH	603	Sarcococca hookeriana humilis	Himalayan Sarcococca	#3 pot	45cm (18")
SJP	470	Skimmia japonica	Japanese Skimmia	#3 pot	60cm (24")
SBA	192	Spiraea bumalda 'Anthony Waterer'	Anthony Waterer Spiraea	#3 pot	60cm (24")
ТХМ	310	Taxus x media 'H.M.Eddie'	H.M.Eddie Yew	1.2m	40cm (16")
VOT	68	Vaccinium ovatum 'Thunderbird'	Thunderbird Evergreen Huckleberry	#3 pot	75cm (30")
VDV	511	Viburnum davidii	David Viburnum	#3 pot	60cm (24")
		Ground Cover			
CDL	289	Cotoneaster dammeri 'Lowfast'	Lowfast Cotoneaster	#1 pot	38cm (15")
ECP	571	Erica carnea 'Springwood Pink'	Spring Pink Winter Heath	#1 pot	38cm (15")
EFE	496	Euonymus fortunei 'Emerald Gaiety'	Emeral Gaiety Wintercreeper	#1 pot	38cm (15")
LSR	282	Liriope spicata	Creeping Lily-turf	#1 pot	38cm (15")
		Perennials			
POL	108	Papaver orientale	Oriental Poppy	#1 pot	38 cm (15")
SSB	50	Salvia superba	Perennial Salvia	#1 pot	30 cm (12")
0.45		Vines	E OL		
CAR	45	Clematis armandii –	Evergreen Clematis	#2 pot	As Shown
		Ferns			
PMU	99	Polystichum munitum	Western Sword Fern	#1 pot	45 cm (18")

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REVISIONS AND ISSUES			
NO.	DATE	DESCRIPTION	
2	2019-11-27	ISSUED FOR AUDP	
3	2020-01-06	DEVELOPMENT PERMIT BOARD SUBMISSION	
4	2020-02-10	RE-ISSUED FOR DEVELOPMENT PERMIT	
5	2020-03-01	ISSUED FOR PRICING	
6	2020-05-29	ISSUED FOR 50% BP	
7	2020-07-16	ISSUED FOR 90% BP	
8	2020-10-29	ISSUED FOR DPMA	
9	2020-10-29	ISSUED FOR TENDER	
10	2021-01-08	ISSUED FOR BUILDING PERMIT	
	NO. 2 3 4 5 6 7 8 9	NO. DATE 2 2019-11-27 3 2020-01-06 4 2020-02-10 5 2020-03-01 6 2020-05-29 7 2020-07-16 8 2020-10-29 9 2020-10-29	

THE CONSERVATORY UBC LOT 5 WESBROOK PLACE

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ADDRESS

DRAWING TITLE

PLANT LIST

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NORTH		SCALE		
Nomin		JEAL		
PROJECT NO.	19037			
DATE	November 2	2019		
FILE NAME	19037 PLA	N.vwx		
PLOTTED	21-1-12			
DRAWN	MB, EW	REVIEWED	BH	

L3.01

Remarks

B&B, Nursery grown, minimum 3 stems
B&B, Uniform branching, dense tree, 7' (2.1 m) std.
B&B, Multi-stemmed, dense tree
B&B, Multi-stem, nursery grown
B&B, Well branched, dense tree
B&B, Dense plant, well branched, fully branched to ground
B&B, Straight trunk, uniform branching, 5' (1.5 m) std.
B&B, Well branched, dense tree


Well established Well established Well established Well established Well established Well established, nursery grown 15cm [6"] height Well established Well established, nursery grown Well established Well established, nursery grown Well established Well established Well established Well established Well established, dense hedging plant / B & B Well established, nursery grown Well established 15cm (6") leads.

15cm (6") height 25cm (10") spread. Minimum 3 leads 25cm (10") spread

Well established Well established

Staked, full development

Well established, nursery grown

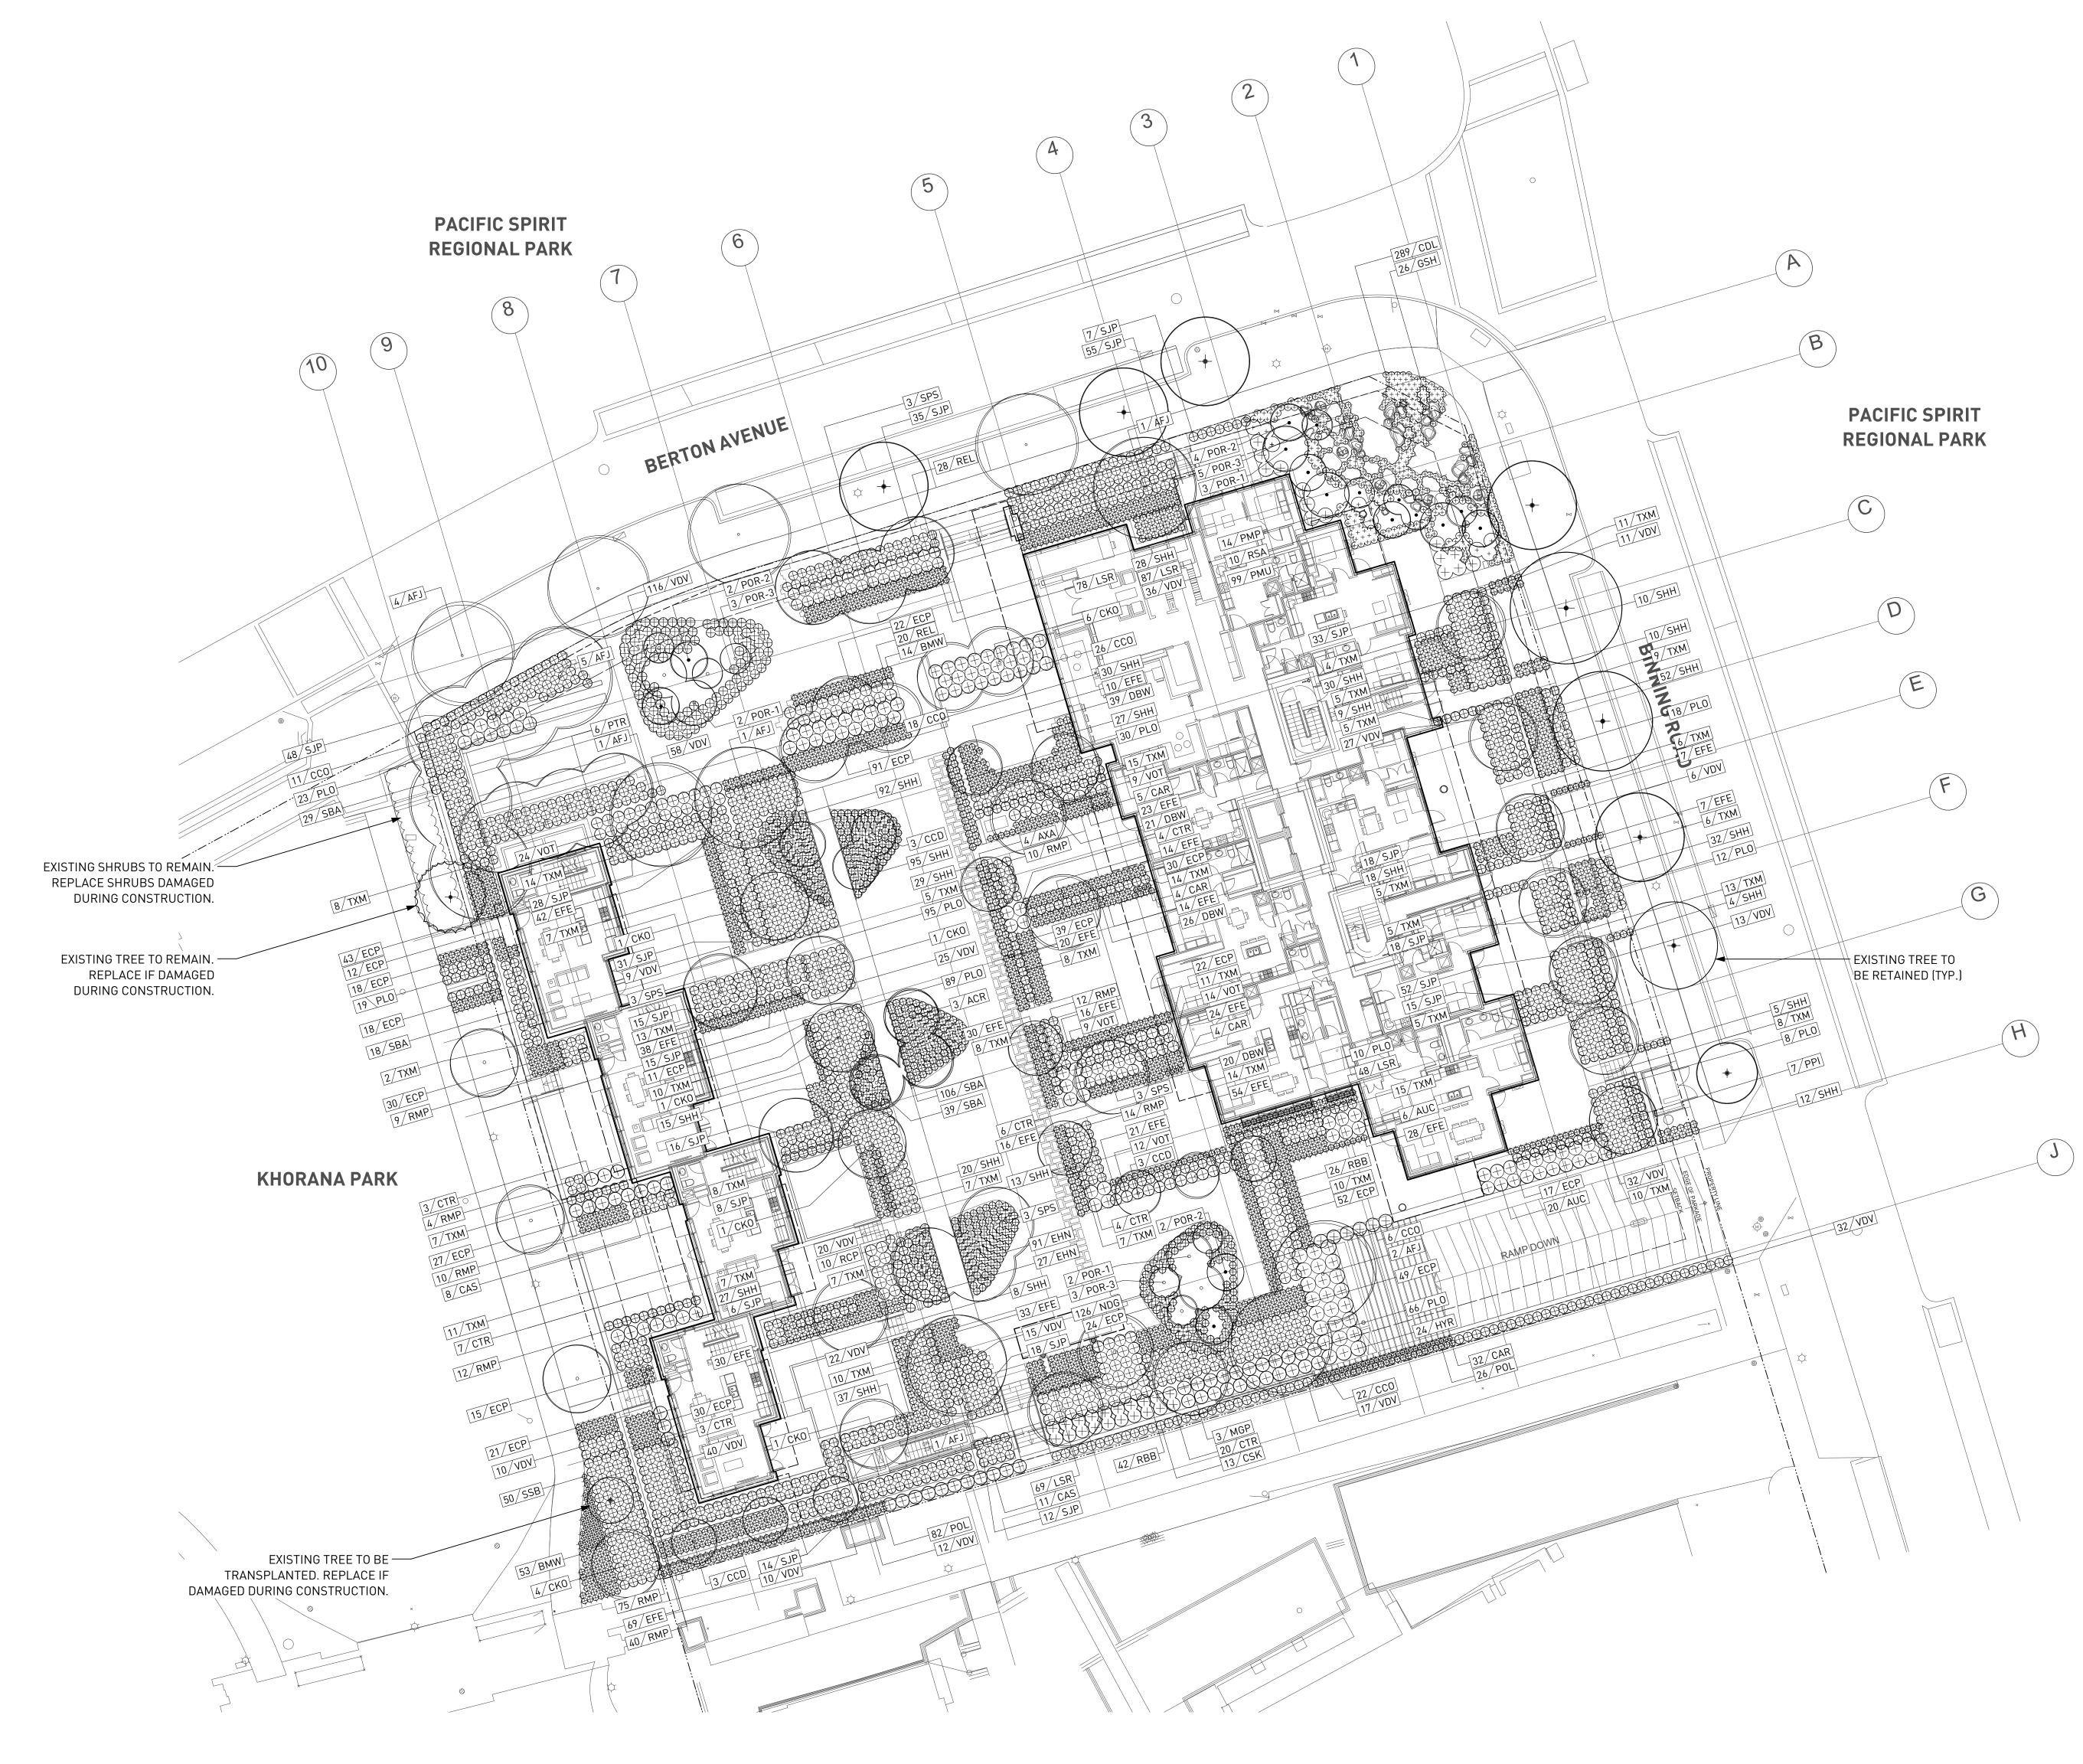

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PLANTING PLAN

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		1/16"=1'0"
PROJECT NO.	19037	
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FILE NAME	19037 PLAN.	vwx
PLOTTED	21-1-12	
DRAWN	MB, EW	REVIEWED BH
DRAWING		

L3.02

LIGHTING LEGEND

DRAWINGS HAS BEEN DEVELOPED FOR REFERENCE TO FACILITATE COORDINATION BETWEEN CONTRACTORS.

REFER TO ELECTRICAL ENGINEERING DRAWINGS FOR FIXTURE TYPES AND LAYOUT, CONTRACTOR TO REPORT ANY DISCREPANCIES TO CONSULTANT FOR COMMENTS.

REFER TO INDICATED ELEVATION DETAILS FOR LIGHT FIXTURE LAYOUT IN LANDSCAPE.

•	BOLLARD LIGHT	
	WALL LIGHT	1 6.10



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LIGHTING PLAN

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 PROJECT NO.
 19037

 DATE
 November 2019

 FILE NAME
 19037 PLAN.vwx


 PLOTTED
 21-1-12

 DRAWN
 MB, EW
 REVIEWED
 BH

 DRAWING

L4.01

SOIL DEPTH LEGEND		
	3' 0" (900mm)	
	12" - 18" (450mm)	
	6" (150mm)	

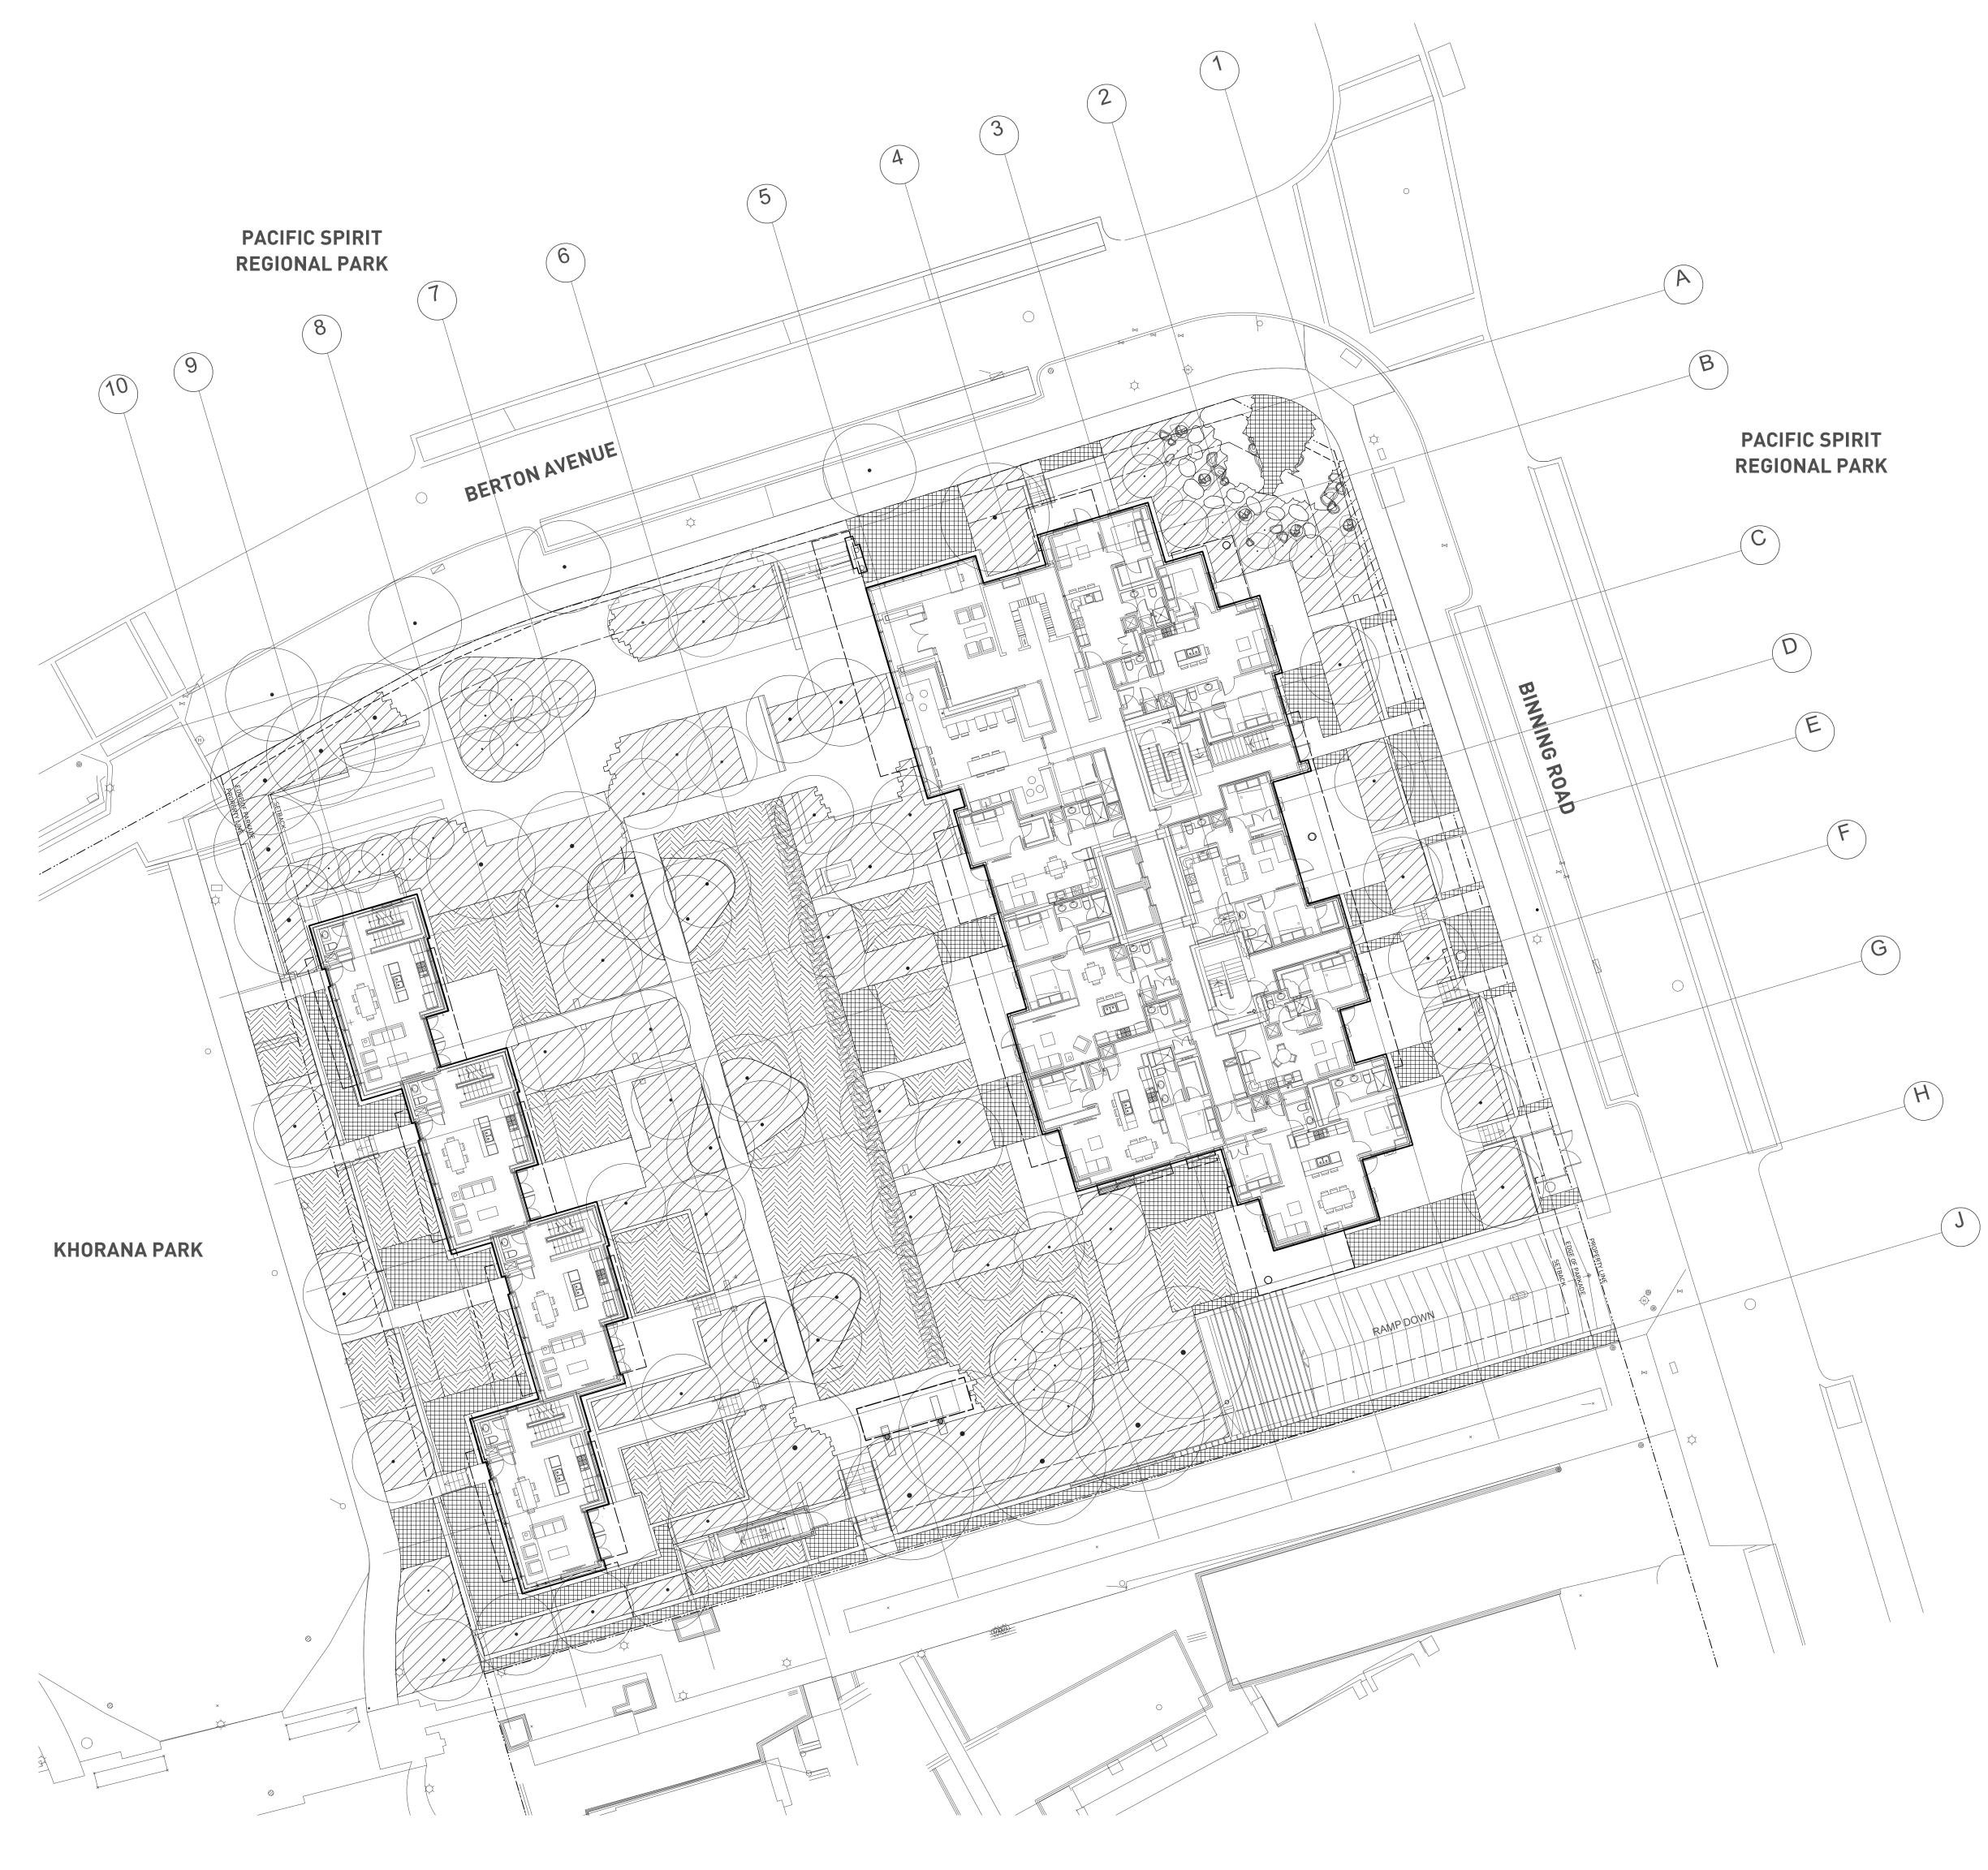

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THE CONSERVATORY UBC LOT 5 WESBROOK PLACE

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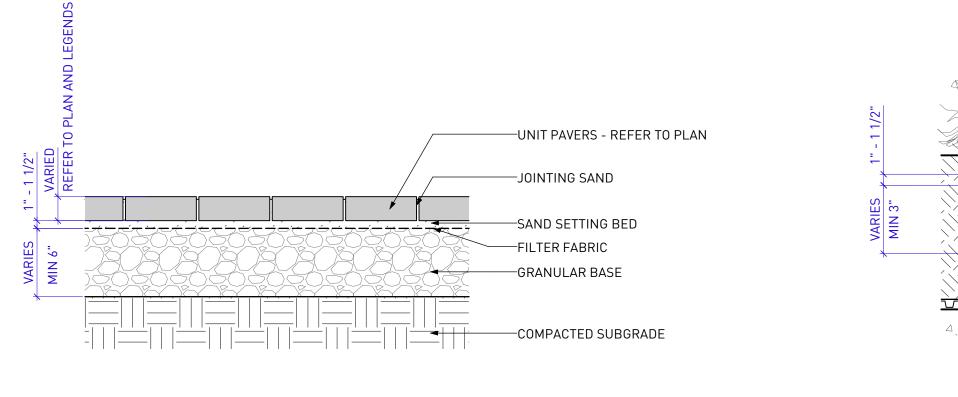
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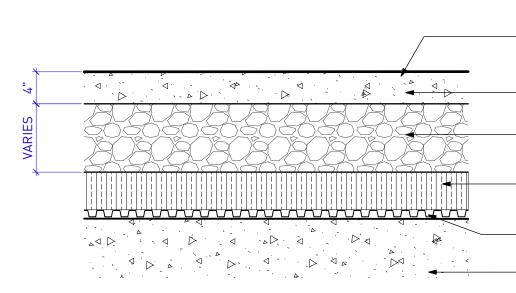
SOIL DEPTH DIAGRAM

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NORTH		scale 1/16"=1'0"
PROJECT NO.	19037	
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FILE NAME	19037 PLA	N.vwx
PLOTTED	21-1-12	
DRAWN	MB, EW	REVIEWED BH
DRAWING		

L5.02







REFER TO PLAN FOR JOINT -LAYOUT AND CONCRETE JOINTING DETAIL


_CAST IN PLACE CONCRETE -REFER TO LEGEND FOR FINISH

-DRAIN ROCK


VOIDING AS REQUIRED TO SUPPORT ADJACENT GROWING MEDIUM DEPTH

ARCHITECTURAL BUILDUP - REFER TO ARCHITECTURAL DRAWINGS _STRUCTURAL SLAB - REFER TO

STRUCTURAL ENGINEER'S DRAWINGS

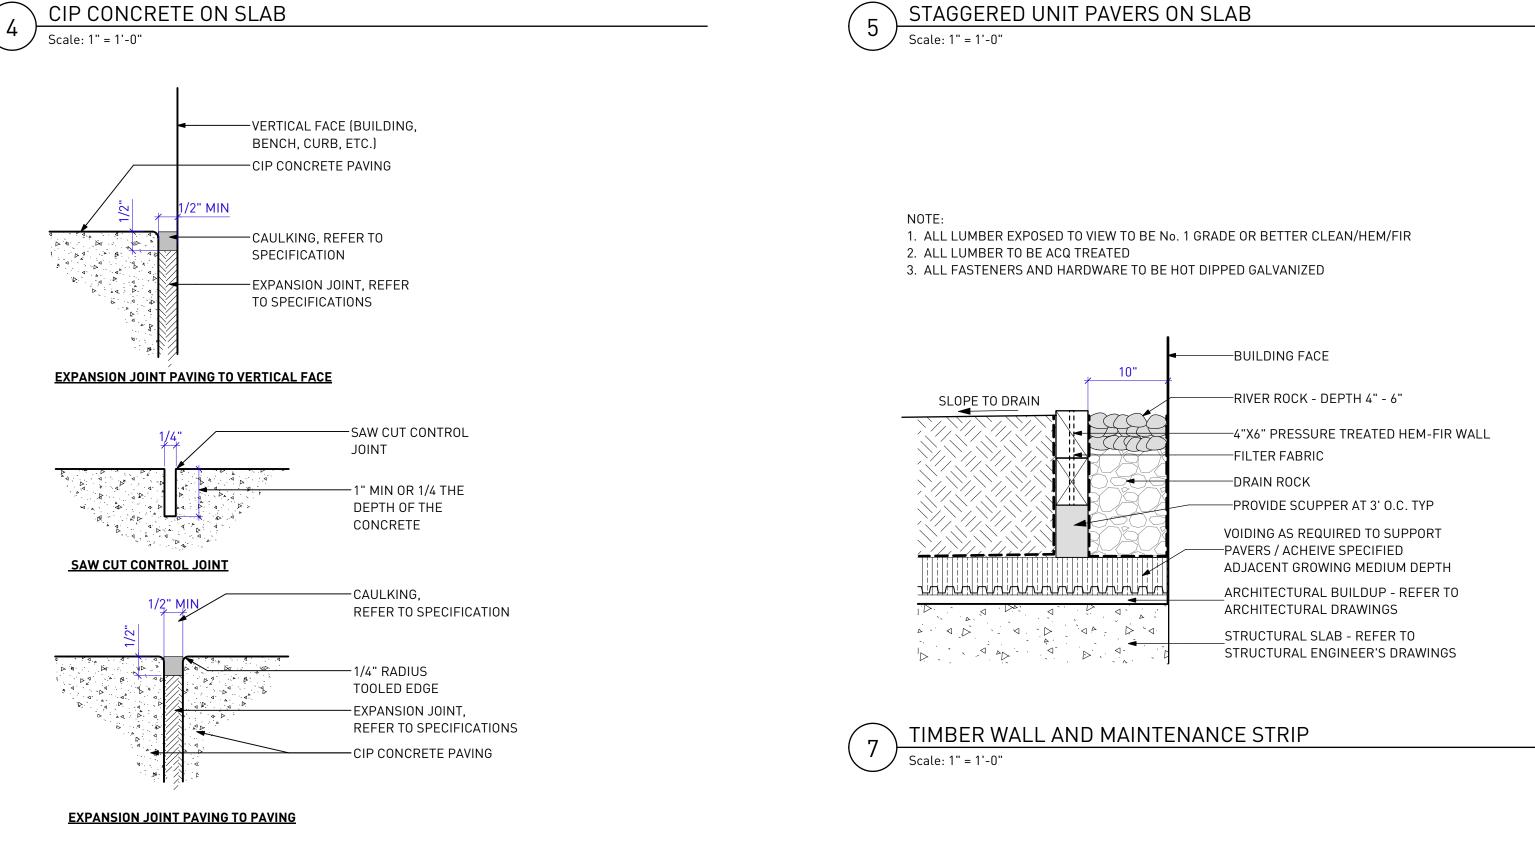


CONCRETE JOINTING 6 Scale: 6"=1'-0"

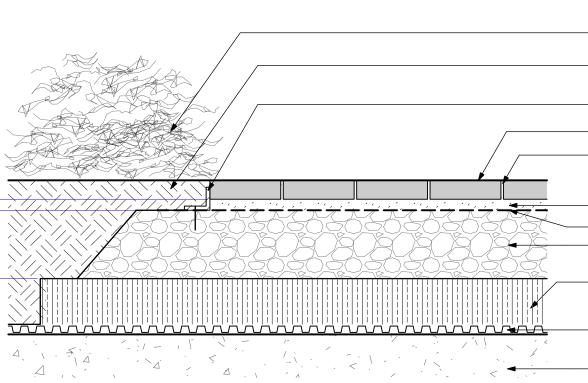


-ADJACENT PLANTING ADJACENT GROWING MEDIUM. REFER TO PLANS PAVER EDGER. B.E.A.S.T BRICKSTOP OR APPROVED EQUAL -JOINTING SAND

-SAND SETTING BED -FILTER FABRIC —DRAIN ROCK VOIDING AS REQUIRED TO SUPPORT ADJACENT GROWING MEDIUM DEPTH ARCHITECTURAL BUILDUP - REFER TO ARCHITECTURAL DRAWINGS STRUCTURAL SLAB - REFER TO STRUCTURAL ENGINEER'S DRAWINGS

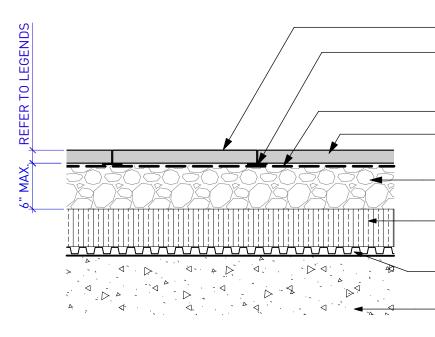

HYDRAPRESSED PAVERS ON SLAB 3 Scale: 1" = 1'-0"

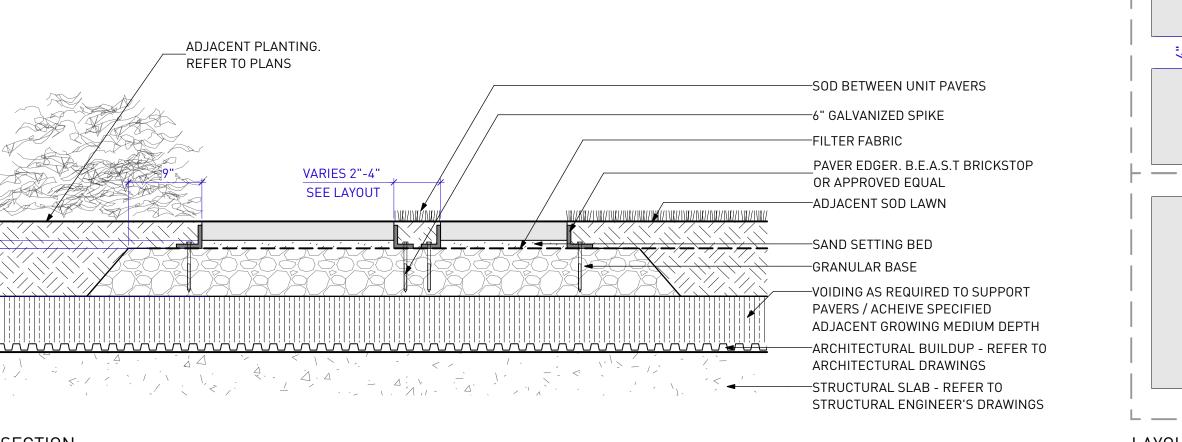


SECTION

UNIT PAVERS ON SLAB


Scale: 1" = 1'-0"

2

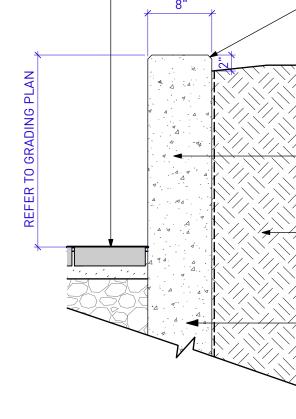



-HYDRAPRESSED SLABS. LAY FLAT WITH NO SLOPE -AWS 1/8" JOIST PLATE SYSTEM AS DISTRIBUTED BY ABBOTSFORD CONCRETE PRODUCTS OR APPROVED EQUAL, SITTING ON 1/2" THICK 6" x 6" NEOPRENE SHIM -FILTER FABRIC -HYDRAPRESSED CONCRETE SLABS. SEE LAYOUT & MATERIALS PLANS FOR TYPE & LOCATIONS. -DRAIN ROCK VOIDING AS REQUIRED TO SUPPORT ADJACENT GROWING MEDIUM DEPTH ARCHITECTURAL BUILDUP - REFER TO ARCHITECTURAL DRAWINGS _STRUCTURAL SLAB - REFER TO STRUCTURAL ENGINEER'S DRAWINGS

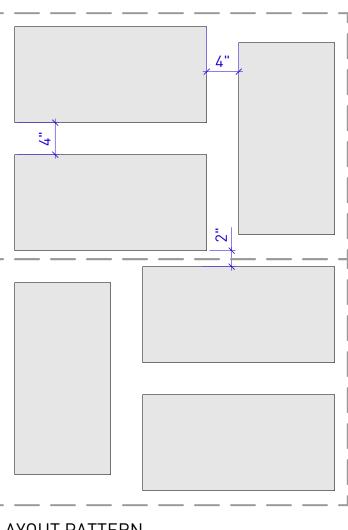

LAYOUT PATTERN

-ADJACENT FINISH, REFER TO PLAN
–PROVIDE 1/2" RADIUS EDGE, TYP. BOTH SIDES
-CAST IN PLACE CONCRETE WALL, REFER TO STRUCTURAL ENGINEER'S DRAWINGS FOR REINFORCING. MEDIUM SANDBLAST FINISH.
-ADJACENT GROWING MEDIUM. REFER TO PLANS
-SEE STRUCTURAL FOR FOOTING DESIGN / CONNECTION TO SLAB. SEE MECHANCIAL FOR FOOTING DRAINAGE IF ON SLAB

8" CONCRETE RETAINING WALL ON GRADE / ON SLAB

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ジー POLYGON

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THE CONSERVATORY UBC LOT 5 WESTBROOK PLACE

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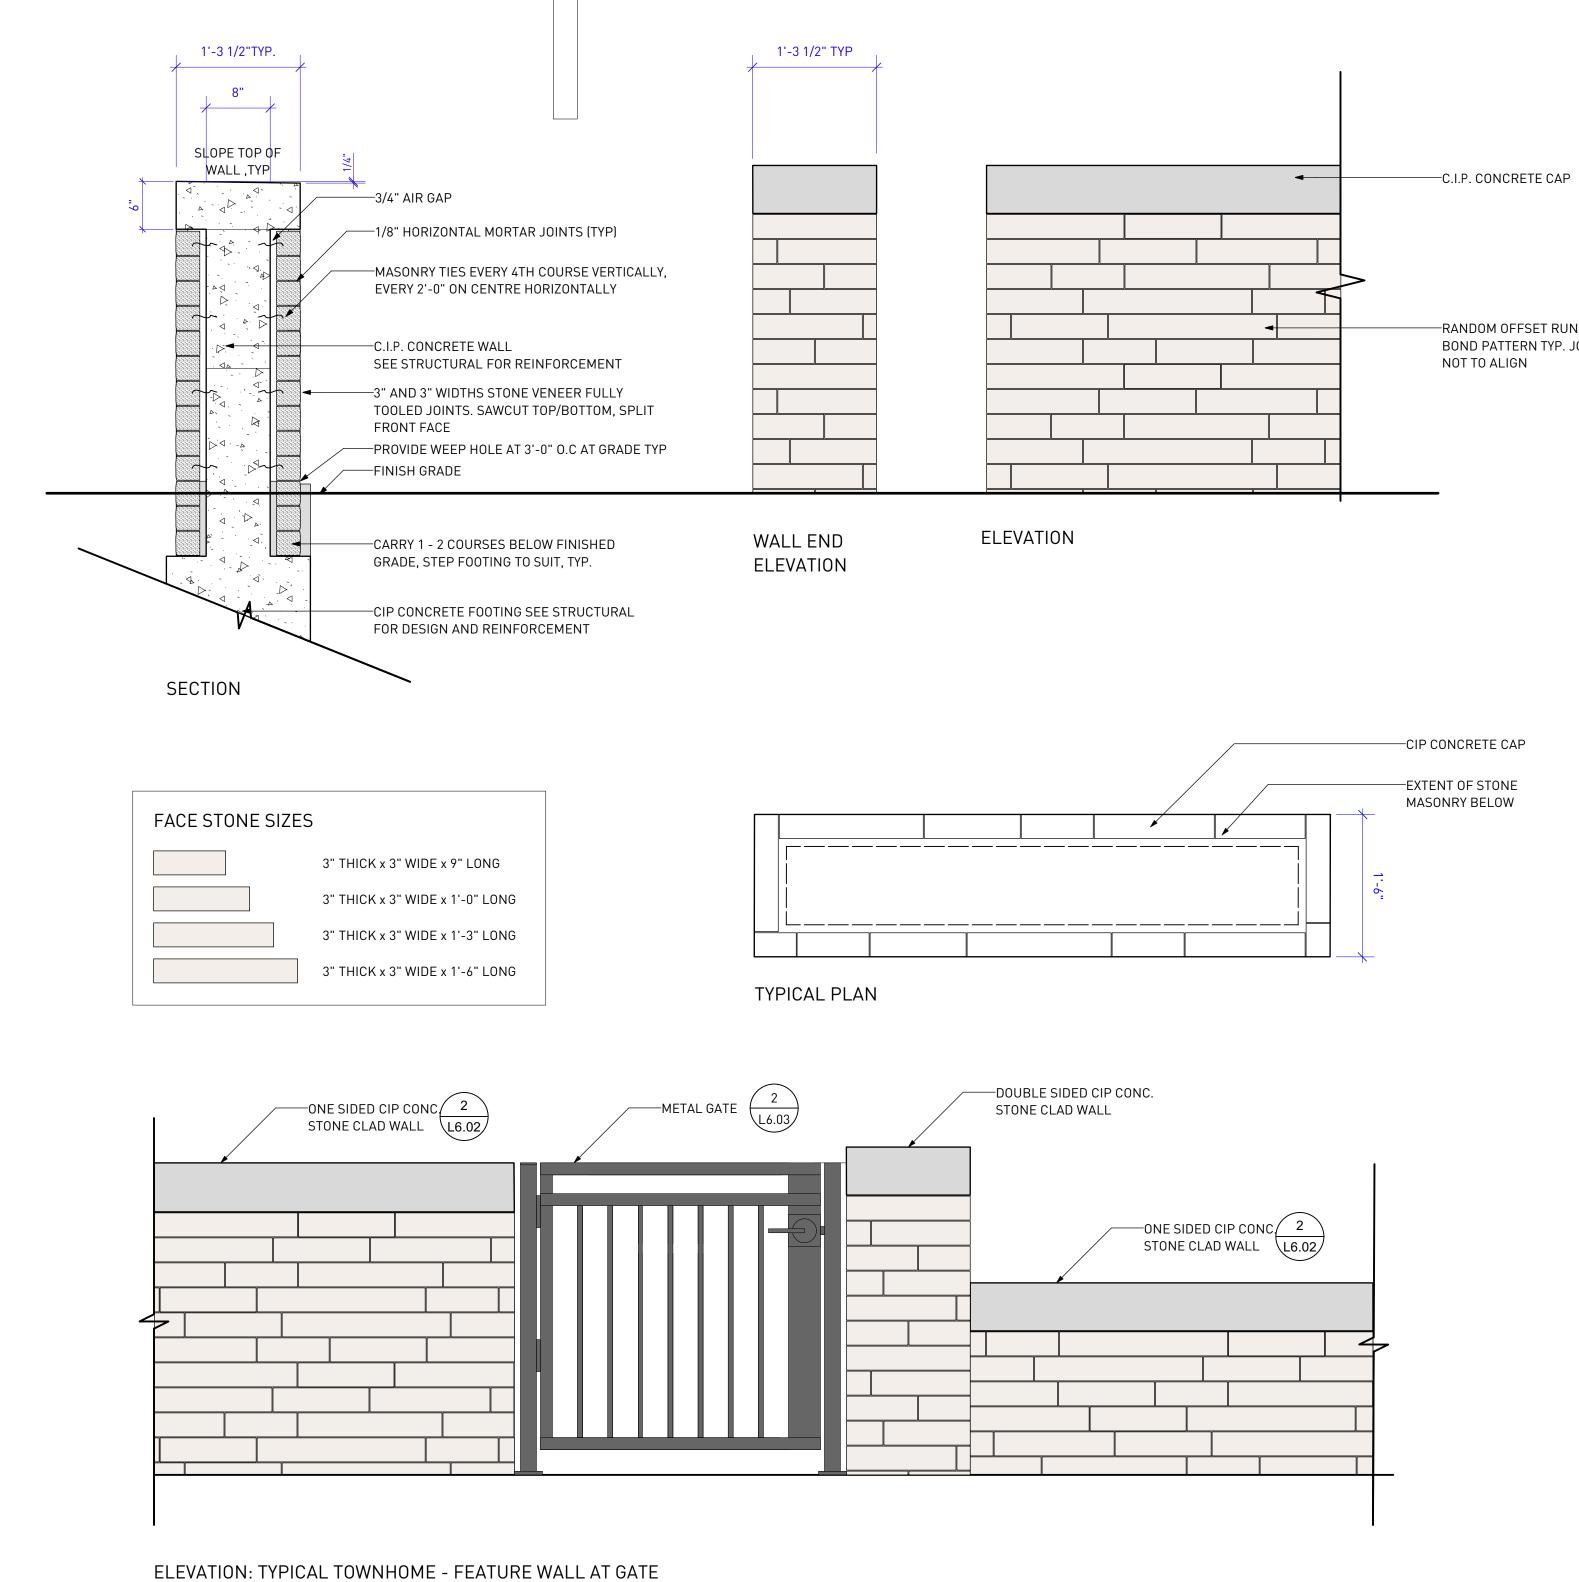
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DETAILS

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DATE	2019-05-10		
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DRAWING			




DOUBLE SIDED - CIP CONCRETE WALL WITH STONE CLADDING Scale: 1" = 1'-0"


-RANDOM OFFSET RUNNING BOND PATTERN TYP. JOINTS NOT TO ALIGN

-CIP CONCRETE CAP


-EXTENT OF STONE MASONRY BELOW

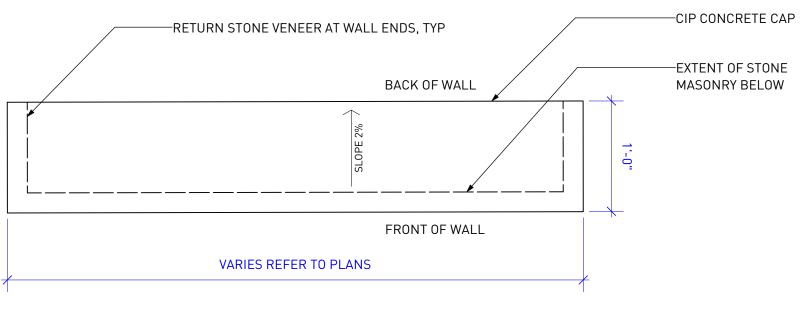

TYPICAL PLAN

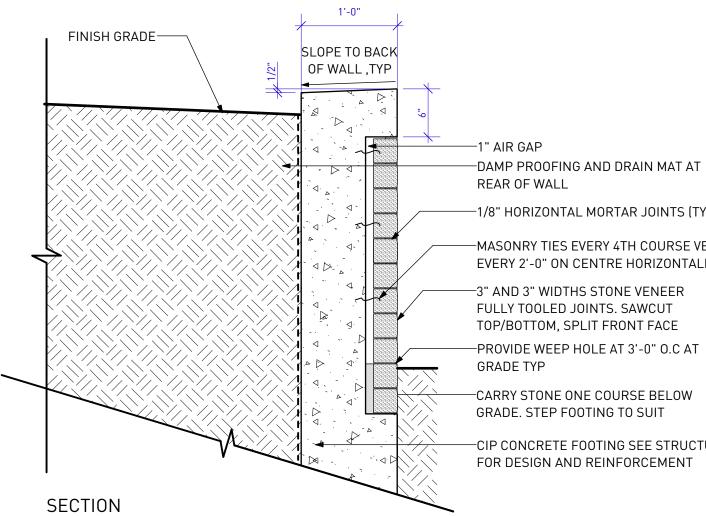



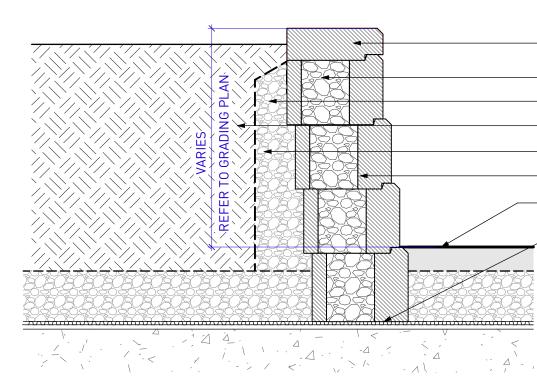



MODULAR BLOCK RETAINING WALL Scale: 1" = 1'-0"

-1/8" HORIZONTAL MORTAR JOINTS (TYP) -MASONRY TIES EVERY 4TH COURSE VERTICALLY, EVERY 2'-0" ON CENTRE HORIZONTALLY -3" AND 3" WIDTHS STONE VENEER FULLY TOOLED JOINTS. SAWCUT TOP/BOTTOM, SPLIT FRONT FACE -PROVIDE WEEP HOLE AT 3'-0" O.C AT -CARRY STONE ONE COURSE BELOW GRADE. STEP FOOTING TO SUIT

-CIP CONCRETE FOOTING SEE STRUCTURAL FOR DESIGN AND REINFORCEMENT

NOTE: 1. INSTALL PER MANUFACTURER'S SPECIFICATIONS

2. REFER TO GRADING PLAN FOR WALL HEIGHT

3. WALL HEIGHT NOT TO EXCEED 2'-0". REPORT DISCREPANCIES TO CONSULTANT

-ALLAN BLOCK UNIT CAPSTONE

- -FREE DRAINING GRANULAR FILL
- -DRAIN ROCK
- -GROWING MEDIUM IN PLANTER
- -FILTER CLOTH
- –ALLAN BLOCK UNIT
- -REFER TO PLAN FOR ADJACENT SURFACE
- -SET WALL ON MIN 24" WIDE PIECE OF DRAIN MAT

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THE CONSERVATORY UBC LOT 5 WESTBROOK PLACE

5608 Berton Avenue, Vancouver BC

PROJECT

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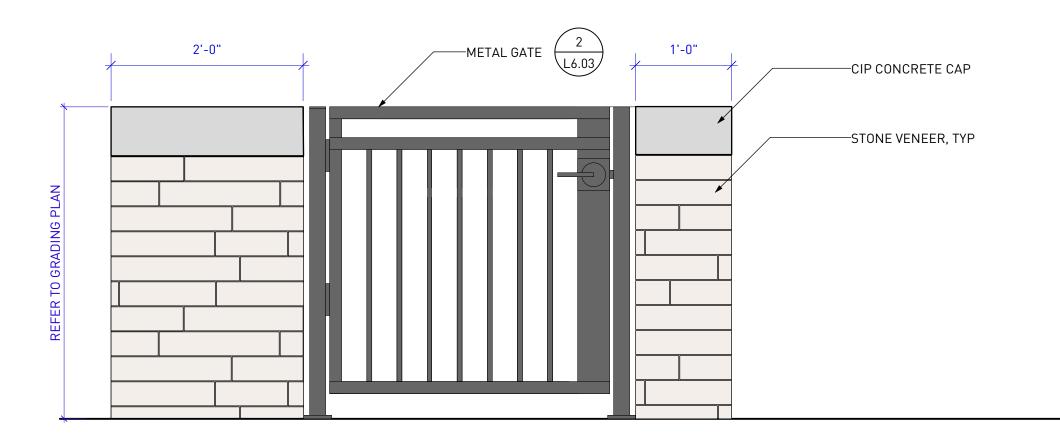
DETAILS

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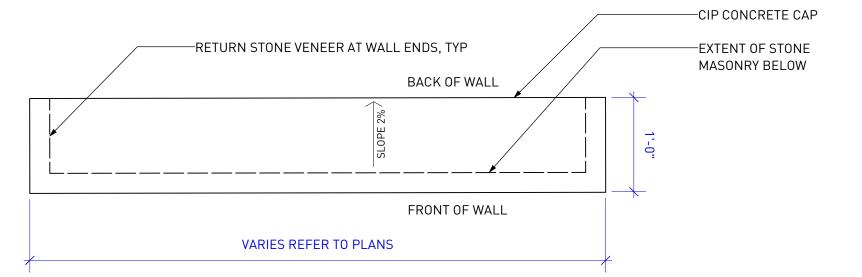
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DRAWING			


ELEVATION: TYPICAL COURTYARD ENTRY PLINTH




TYPICAL PLAN





SECTION

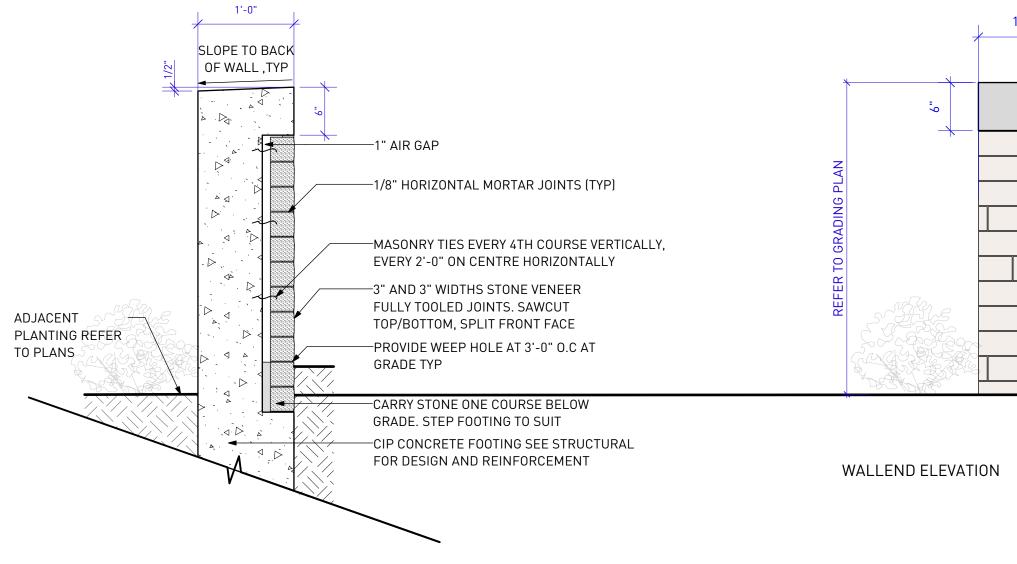

l'-0" 	PROVIDE 3mm STONE-RUBBED CHAMFER ON TOP EDGES OF WALL
-	MORTAR WITH TOOLED JOINTS, TYP
	STONE VENEER, TYP

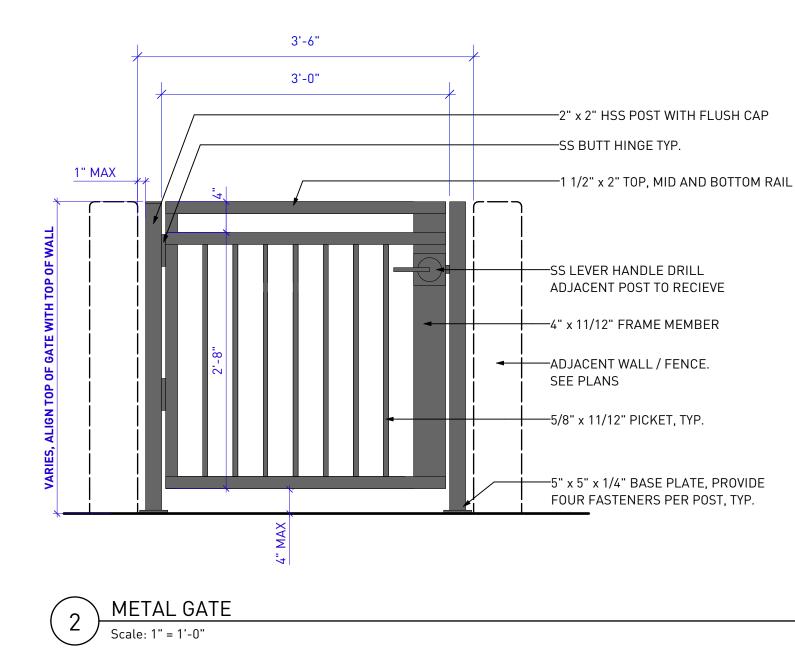

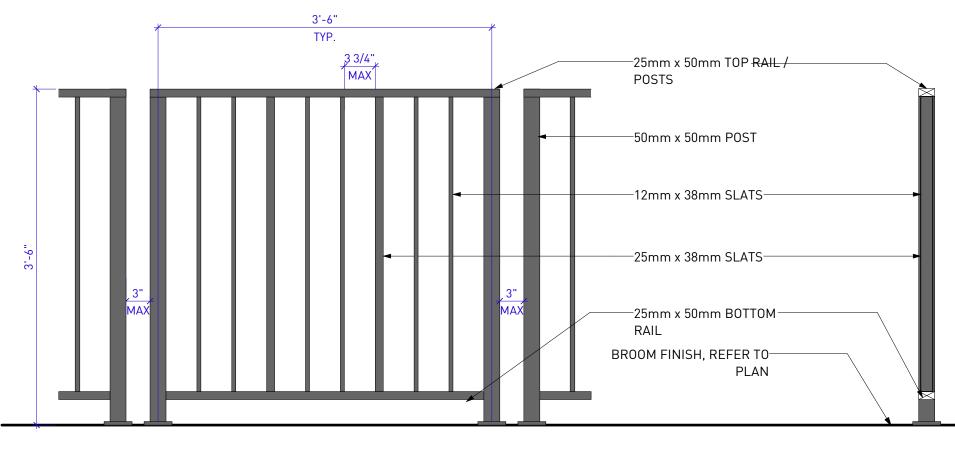

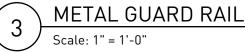

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NOTE: 1. CONTRACTOR TO PROVIDE SHOP DRAWINGS TO BE REVIEWED AND APPROVED BY LANDSCAPE ARCHITECT PRIOR TO FABRICATION 2. ALL GATE DIMENSIONS TO SUIT FIELD MEASURED OPENING, TYP. 3. ALL PORTIONS OF GATE TO BE PAINTED ALUMINUM 4. ALL FASTENERS TO BE STAINLESS STEEL UNLESS OTHERWISE SPECIFIED 5. CONTRACTOR TO CARRY OUT MEASUREMENTS IN THE FIELD PRIOR TO FABRICATION 6. STRUCTURE TO BE POWDERCOATED STEEL, RAL 7022 UMBRA GREY



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5	2020-10-29	ISSUED FOR TENDER	
6	2021-01-08	ISSUED FOR BUILDING PERMIT	

NOTES:

1. PROVIDE ENGINEERED SHOP DRAWINGS TO CONSULTANT FOR APPROVAL PRIOR TO FABRICATION. SUBMISSION TO INCLUDE SEPARATE ENGINEERED SHOP DRAWINGS FOR DOG PARK DOUBLE GATE ENTRIES.

2. STRUCTURE TO BE POWDERCOATED STEEL, RAL 7022 UMBRA GREY

3. ALL WELDS TO BE CONTINUOUS AND GROUND SMOOTH; NO SPOT WELDS.

4. BOLTED CONNECTIONS TO BE ASSEMBLED ON SITE ONLY. RECEPTORS TO BE PRE-DRILLED - NOT TO BE DRILLED ON SITE.

THE CONSERVATORY UBC LOT 5 WESTBROOK PLACE

5608 Berton Avenue, Vancouver BC


PROJECT


ADDRESS

DRAWING TITLE DETAILS


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NORTH		SCALE	
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PROJECT NO.	19037		
DATE	2019-05-10		
FILE NAME	19037 DETAI	LS.vwx	
PLOTTED	2020-10-29		
DRAWN	MB	REVIEWED	BH
DRAWING			



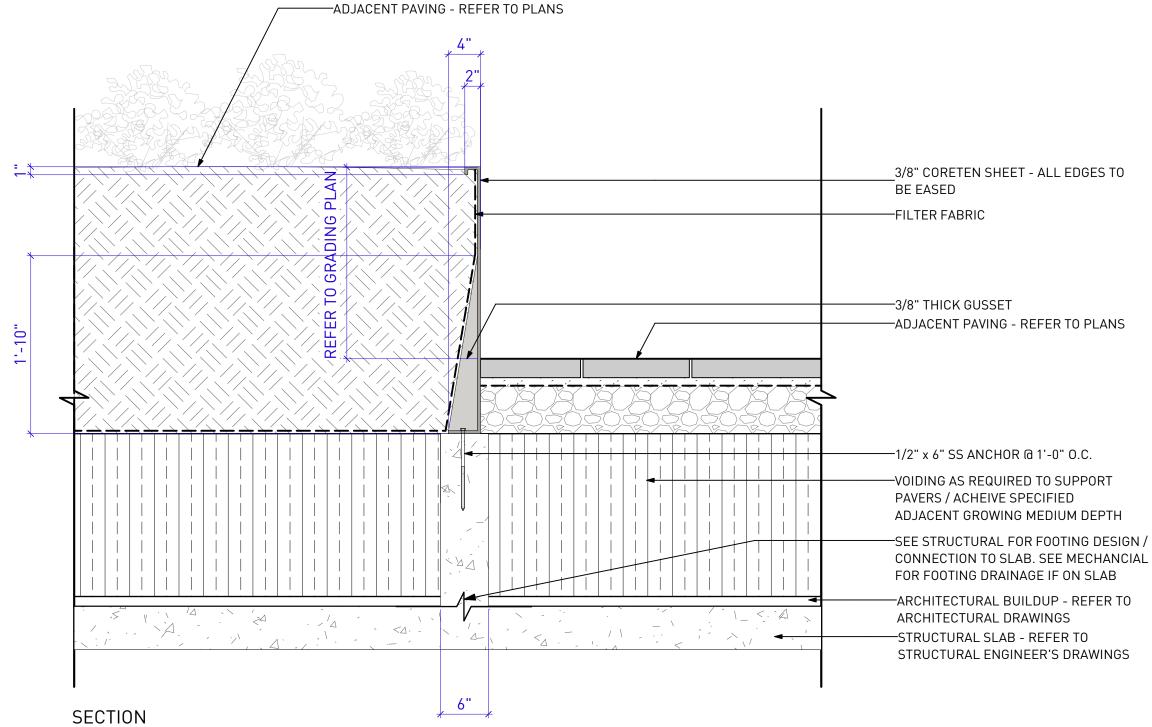

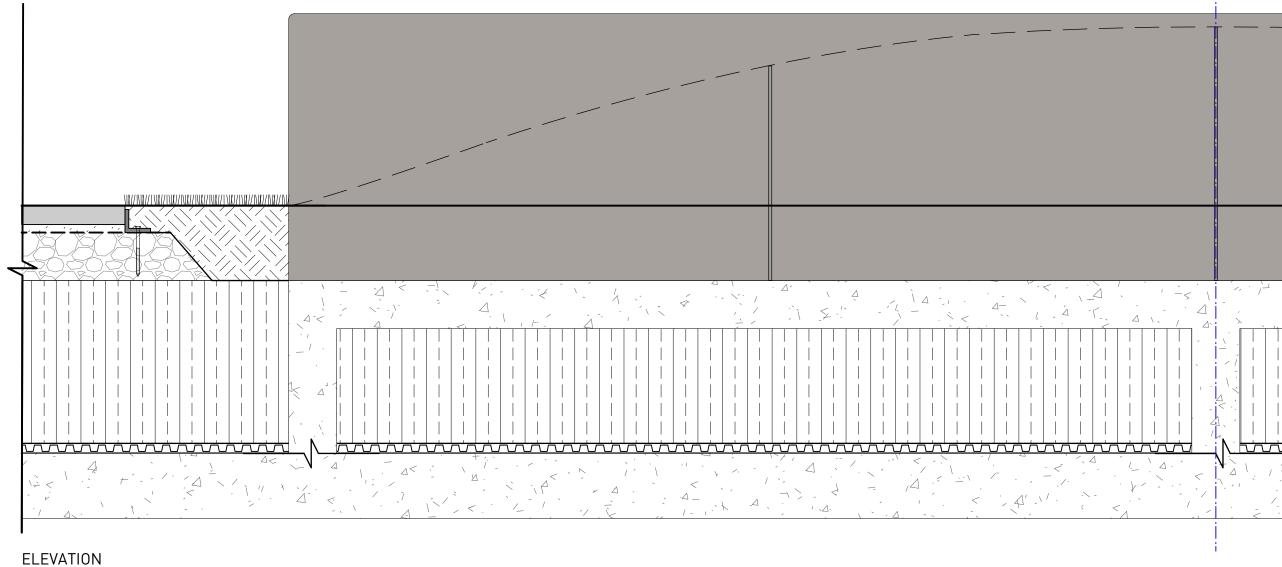CORTEN STEEL RETAINING WALL Scale: 1" = 1'-0"

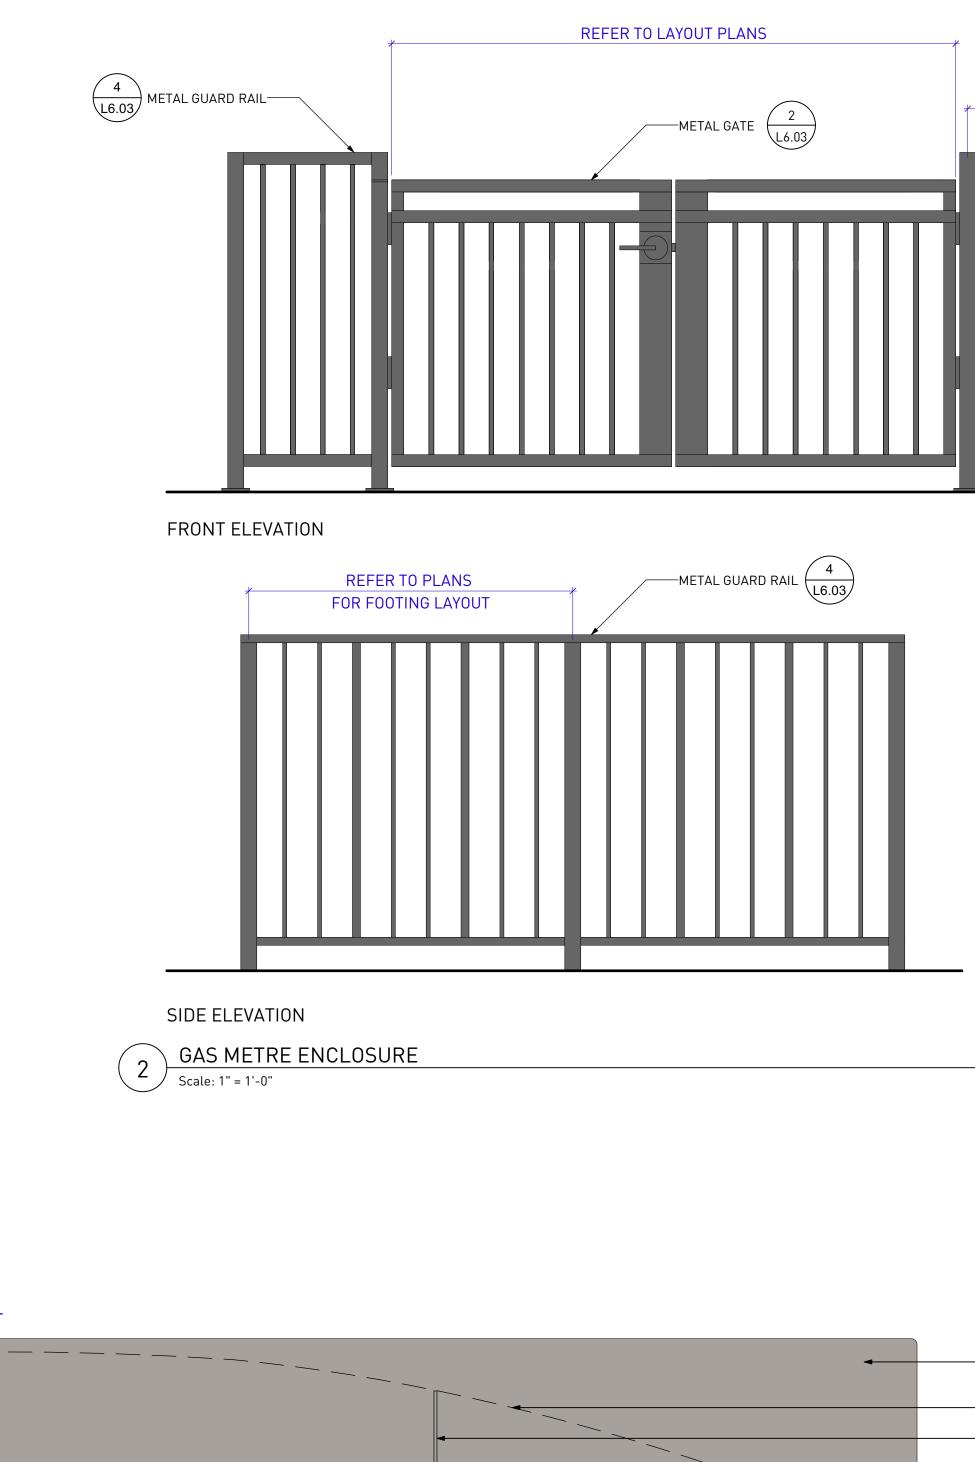

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PWL Partnership Landscape Architects Inc 5th Floor, East Asiatic House 1201 West Pender Street Vancouver BC Canada V6E 2V2 www.pwlpartnership.com T 604.688.6111 F 604.688.6112





REVISIONS AND ISSUES			
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6	2021-01-08	ISSUED FOR BUILDING PERMIT	

THE CONSERVATORY UBC LOT 5 WESTBROOK PLACE

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ADDRESS


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NOTES:


1. PROVIDE ENGINEERED SHOP DRAWINGS TO CONSULTANT FOR APPROVAL PRIOR TO FABRICATION. SUBMISSION TO INCLUDE SEPARATE ENGINEERED SHOP DRAWINGS FOR DOG PARK DOUBLE GATE ENTRIES.

2. ALL GATE DIMENSIONS TO SUIT FIELD MEASURED OPENING, TYP.

3. STRUCTURE TO BE POWDERCOATED STEEL, RAL 7022 UMBRA GREY

4. ALL WELDS TO BE CONTINUOUS AND GROUND SMOOTH; NO SPOT WELDS.

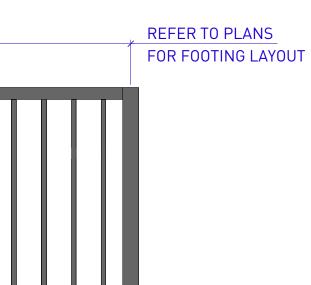5. BOLTED CONNECTIONS TO BE ASSEMBLED ON SITE ONLY. RECEPTORS TO BE PRE-DRILLED -NOT TO BE DRILLED ON SITE.

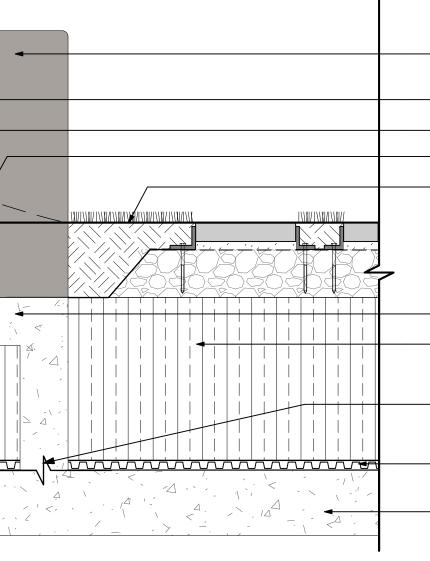


-CORETEN SHEET (ONE SHEET, NO JOINTS) -LANDSCAPE BERM BEYOND


-GUSSET


-FINISHED GRADE ADJACENT PLANTING AND PAVING -REFER TO PLANS


-CIP CONCRETE WALL BELOW GRADE -VOIDING AS REQUIRED TO SUPPORT PAVERS / ACHEIVE SPECIFIED ADJACENT GROWING MEDIUM DEPTH -SEE STRUCTURAL FOR FOOTING DESIGN / CONNECTION TO SLAB. SEE MECHANCIAL FOR FOOTING DRAINAGE IF ON SLAB -ARCHITECTURAL BUILDUP - REFER TO ARCHITECTURAL DRAWINGS

-STRUCTURAL SLAB - REFER TO STRUCTURAL ENGINEER'S DRAWINGS

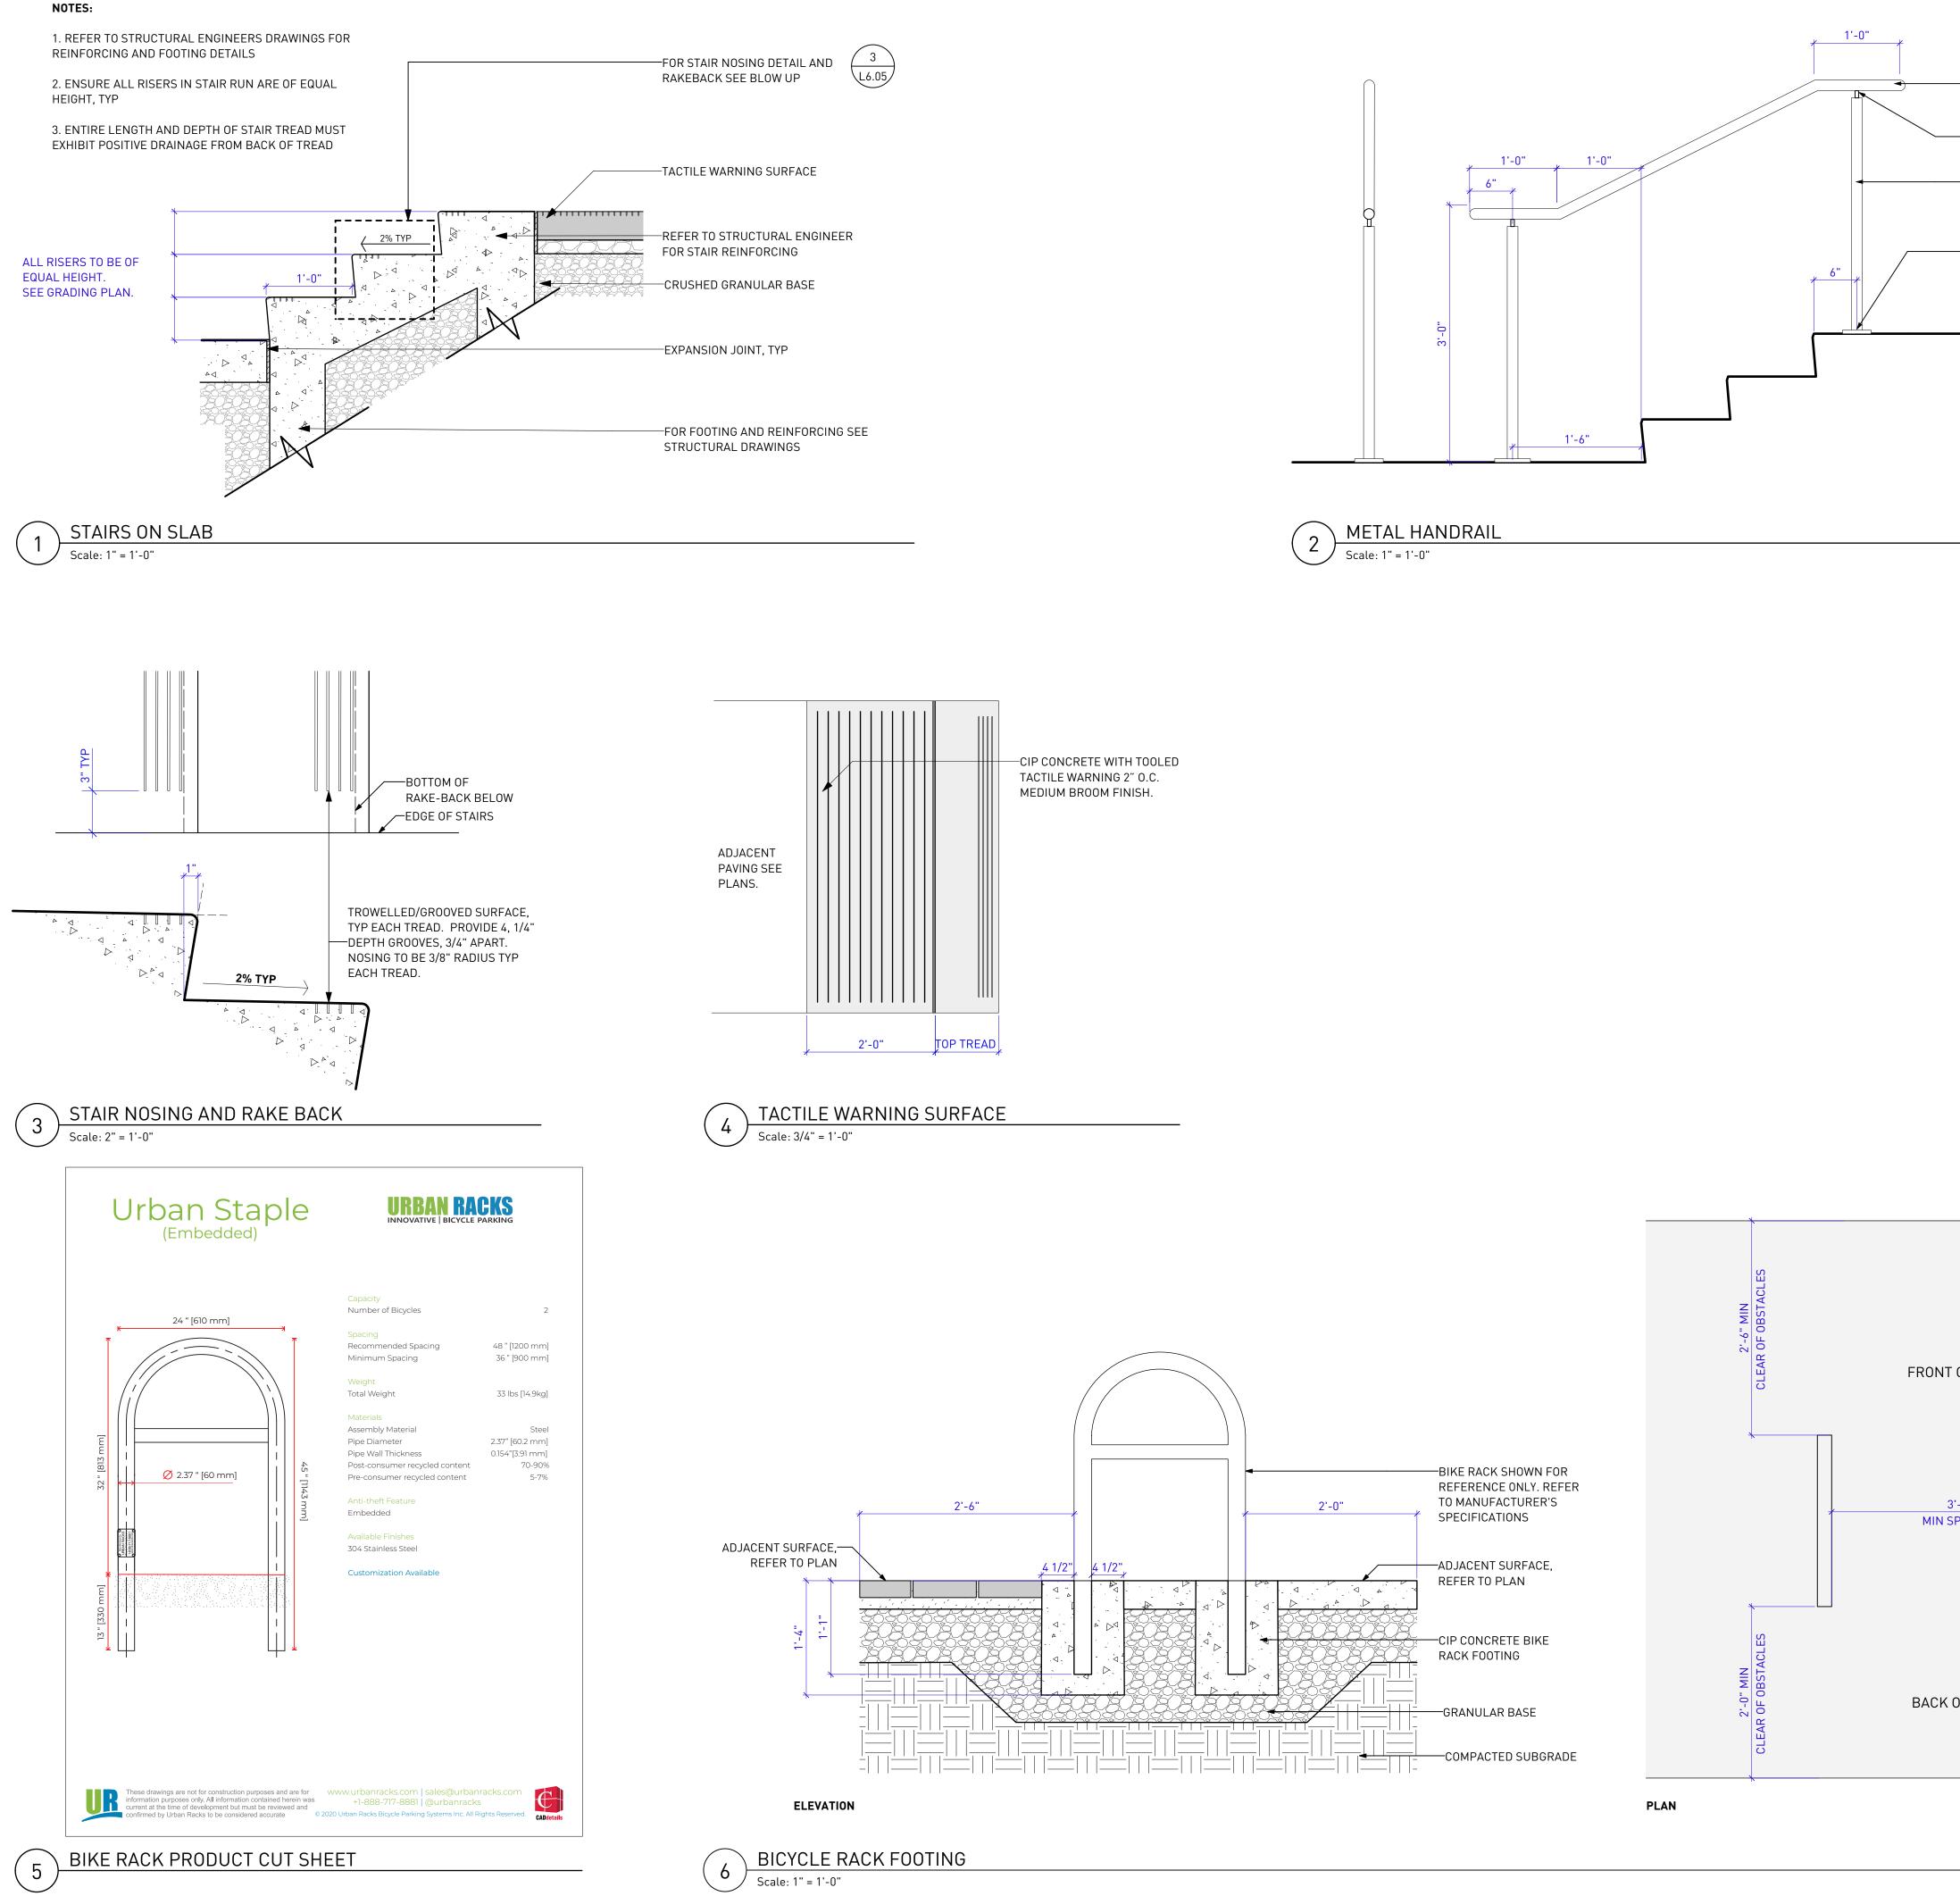

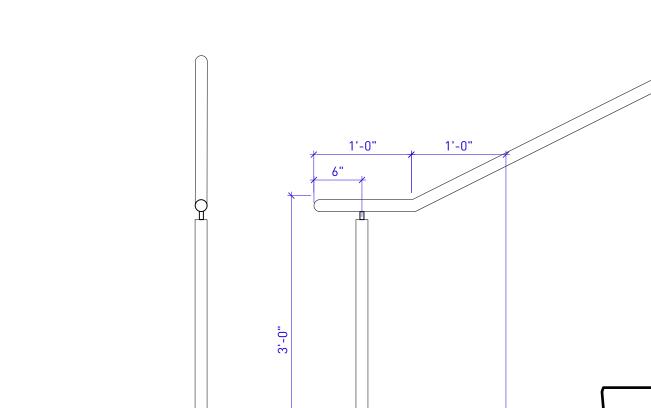

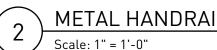

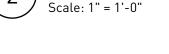

-1-1/2" DIA. ROUND METAL HANDRAIL. SCHEDULE 40, TYP.

-1/2" DIA METAL MOUNTING PIN

2" DIA. ROUND METAL POST. SCHEDULE 40, TYP.

4"x4"x1/8" MOUNTING PLATE -COMPLETE WITH FOUR SS FASTENERS

NOTE:

1. CONTRACTOR TO PROVIDE ENGINEERED SHOP DRAWINGS TO BE REVIEWED AND APPROVED BY LANDSCAPE ARCHITECT PRIOR TO FABRICATION

2. SEE MATERIALS PLAN LEGEND FOR METAL FINISH

3. ALL FASTENERS TO BE STAINLESS STEEL UNLESS OTHERWISE SPECIFIED

4. CONTRACTOR TO CARRY OUT MEASUREMENTS IN THE FIELD PRIOR TO FABRICATION

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THE CONSERVATORY
UBC LOT 5
WESTBROOK PLACE

5608 Berton Avenue, Vancouver BC

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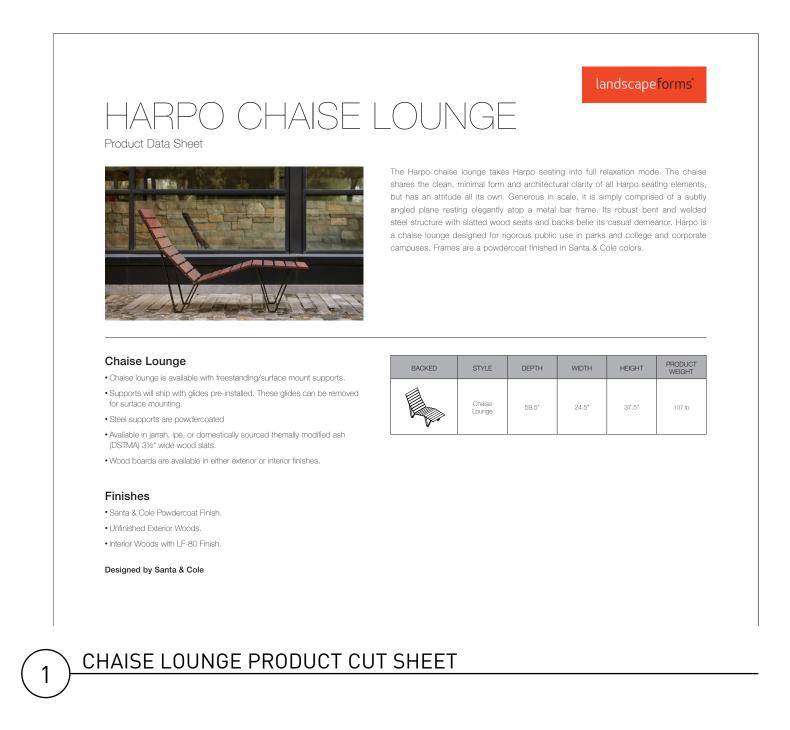
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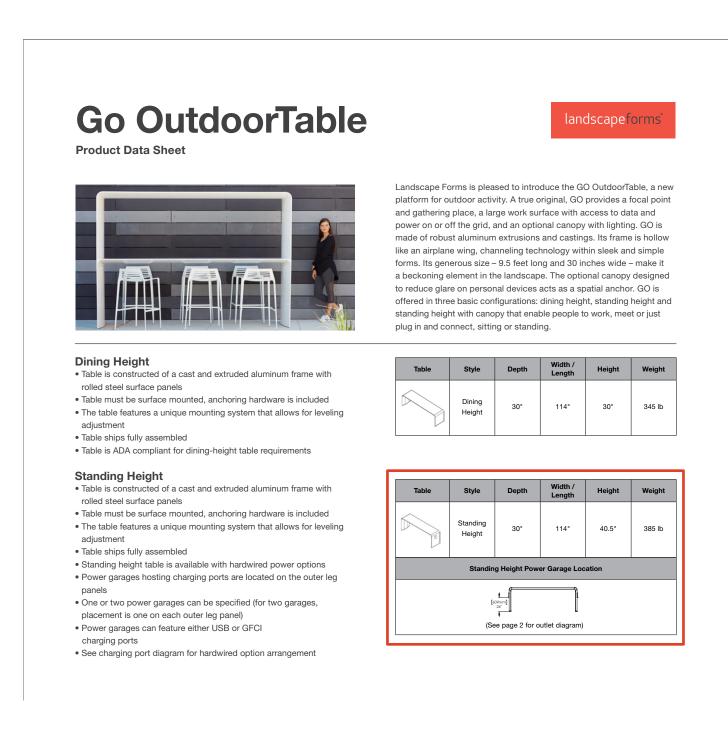
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DF RACK		





COWORK TABLE PRODUCT CUT SHEET

	HARPO LOUNGI	ECHAR	
	Product Data Sheet	The Harpo lounge chair takes the minimal form and international appeal of the Harpo bench into a more casual realm. The lounge chair has arms and a high backrest for exceptional comfort, while its robust bent and welded steel structure with slatted wood seats and backs provide performance and durability in high use public, corporate, cam- pus and healthcare settings. Frames are powdercoat finished in Santa & Cole colors.	HARPO
	 Lounge Chair Lounge chair is available with freestanding, surface mount, or embedded supports. Steel supports are powdercoated. Available only in jarrah, ipe, or domestically sourced thermally modified ash (DSTMA) 3½" wide wood slats. Supports have arms welded on. Wood boards are available in either exterior or interior finishes. 	BACKED STYLE DEPTH WIDTH HEIGHT PRODUCT WEIGHT Image: Chair 32.25" 24.5" 35.5" 77 lb	Product Data Sheet
2	Onfinished Exterior Woods. Interior Woods with LF-80 Finish. Designed by Santa & Cole LOUNGE CHAIR PRODUCT CU	<u>T SHEET</u>	 Benches are available backed or backless. Benches are available with freestanding, surface mount, or embedded supports. The steel supports come in a powdercoat finish. Backed supports have end arms welded on. Backless benches have no arms. Benches are available in either wide anodized aluminum boards, narrow wood slats, or wide wood slats. Wide boards are 3½* wide. Narrow boards are 1-3/8* wide. No color option available for anodized aluminum boards. Wood pards are available in either exterior or interior finishes.
	CHIPMAN Product Data Sheet	landscapeforms [*]	
	Chair 9. Not frame of Chipman is formed of aluminum castings welded together to make the final form. 9. Novdercoated seating is offered armless, or with arms, is lightweight and nests. 9. Bumper/glides are made of tough nylon to resist damage from dragging on rough surfaces.	CHARSTYLEDEPTHWIDTHHEIGHTPRODUCT WEIGHTImage: Style sty	page 1 of 2
	 Stool The frame of Chipman is formed of aluminum castings welded together to make the final form. Powdercoated seating is offered armless, or with arms, is lightweight and nests. Bumper/glides are made of tough nylon to resist damage from dragging on rough surfaces. Finishes All metal is finished with Landscape Forms' proprietary Pangard II® polyester powdercoat, a hard yet flexible finish that resists rusting, chipping, peeling and fading. 	STOOL STYLE DEPTH WIDTH HEIGHT PRODUCT WEIGHT Image: Stool 19" 22" 35" 18 lb	3 BENCH PRODUCT CUT SHEE
	 call for standard color chart. Call for standard color chart. Table: Select table shape and size, style, and powdercoat color. Specify surface mount or freestanding. Select with or without umbrella hole for dining table only. If specified with umbrella, table must be surface mounted. Chair: Select chair with arms, or armless, and powdercoat color. Stool: Select powdercoat color. Visit http://pricebook.landscapeforms.com Designed by Robert Chipman 	Visit our landscapeforms.com for more information. Specifications are subject to change without notice. Landscape Forms supports the Landscape Architecture Foundation at the Second Century level. @2018 Landscape Forms, Inc. Printed in U.S.A. Landscape Forms, Inc. 800.521.2546 F 269.381.3455 7800 E. Michigan Ave., Kalamazoo, MI 49048	

COWORK STOOL PRODUCT CUT SHEET

5

PWL partnership

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dys architecture 260 - 1770 Burrard Street Vancouver BC V6J 3G7 tel 604 669 7710 www.dysarchitecture.com



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THE CONSERVATORY UBC LOT 5 WESTBROOK PLACE

5608 Berton Avenue, Vancouver BC

PROJECT

ADDRESS

DETAILS

DRAWING TITLE

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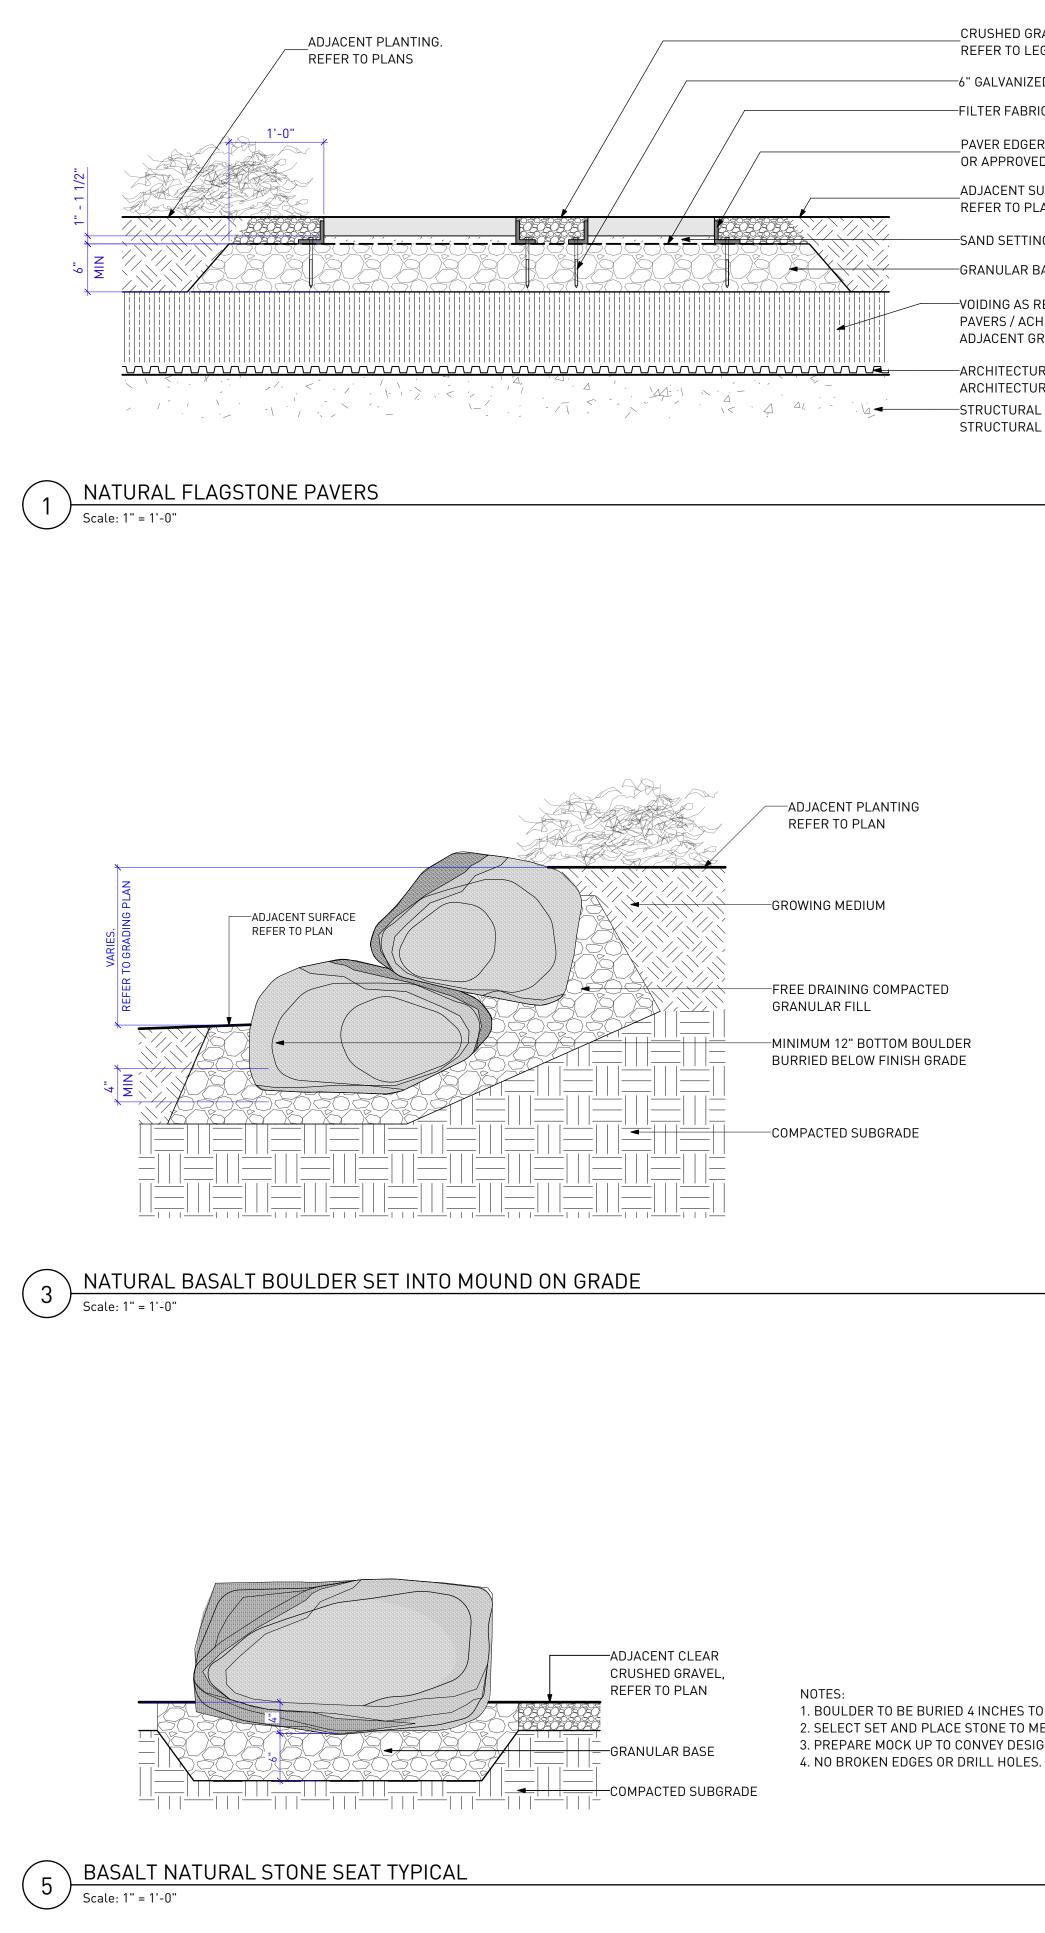
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FILE NAME	19037 DETAI	LS.vwx	
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landscapeforms

Harpo is a new bench collection from global partner Santa & Cole that includes a bench in two lengths. Designed by the distinguished father-and-son team Miguel and Gonzalo Milá, Harpo is international in expression and universally applicable to streetscapes, public parks and private spaces. This is design refined to its essentials. The visual language is pure, clean and architectural. Slim in profile and robust in structure, Harpo has a formed steel frame with slatted seats and backs. A choice of wide aluminum slats or wood slats in wide and narrow widths allows distinct aesthetic approaches. Wide aluminum slats are anodized. Steel frames are powder coat finished in standard Landscape Forms colors.

BACKED	STYLE	DEPTH	WIDTH	HEIGHT	PRODUCT WEIGHT
	24" Narrow Wood Slats	23"	24"	31"	58 lb
	24° Wide Wood Slats	23"	24*	31"	60 lb
	24" Aluminum Slats	23"	24*	31"	56 lb
	69" Narrow Wood Slats	23"	69"	31"	92 lb
	69" Wide Wood Slats	23"	69"	31"	96 lb
	69" Aluminum Slats	23"	69"	31"	82 lb



CRUSHED GRANULAR REFER TO LEGEND

—6" GALVANIZED SPIKE -FILTER FABRIC

PAVER EDGER. B.E.A.S.T BRICKSTOP OR APPROVED EQUAL


ADJACENT SURFACE REFER TO PLANS

-SAND SETTING BED -GRANULAR BASE

-VOIDING AS REQUIRED TO SUPPORT PAVERS / ACHEIVE SPECIFIED ADJACENT GROWING MEDIUM DEPTH

-ARCHITECTURAL BUILDUP - REFER TO ARCHITECTURAL DRAWINGS —STRUCTURAL SLAB - REFER TO

STRUCTURAL ENGINEER'S DRAWINGS

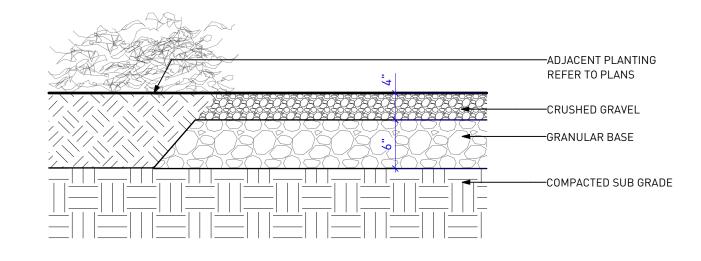




CRUSHED GRANULAR ADJACENT PLANTING ' Scale: 1" = 1'-0"

GENERAL NOTES:

1. INFILL ALL GAPS BETWEEN STONES WITH GROWING MEDIUM 2. BOULDER SIZE: MIN. 300 X 300MM SHAPE: NATURAL ROUNDED PLACEMENT: TIGHT FITTING, SMALL GAPS, SECURE FIT (NO MOBILITY) 3. FROM ONSITE STORAGE 4. NO SPLIT FACES EXPOSED 5. CONSULTANT TO OVERSEE STONE PLACEMENT ON SITE

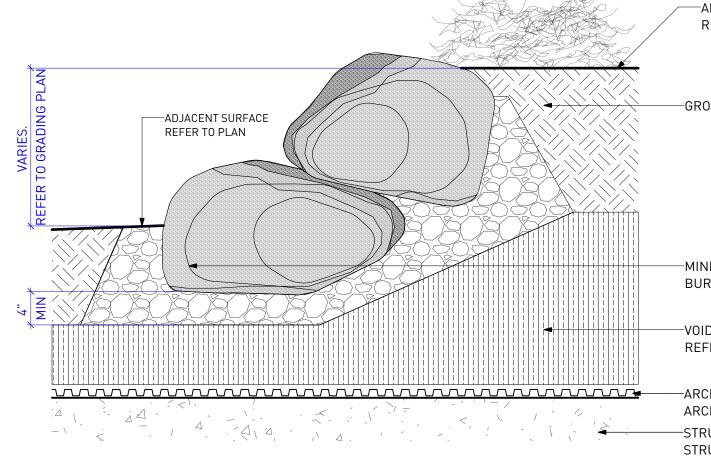



1. BOULDER TO BE BURIED 4 INCHES TO ENSURE STONE IS STABLE. 2. SELECT SET AND PLACE STONE TO MEET DESIGN INTENT. 3. PREPARE MOCK UP TO CONVEY DESIGN INTENT FOR REVIEW.

PWL partnership

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-ADJACENT PLANTING REFER TO PLAN

-GROWING MEDIUM

-MINIMUM 12" BOTTOM BOULDER BURRIED BELOW FINISH GRADE

-VOIDING AS REQURIED REFER TO STRUCTURAL

-ARCHITECTURAL BUILDUP - REFER TO ARCHITECTURAL DRAWINGS STRUCTURAL ENGINEER'S DRAWINGS

GENERAL NOTES:

1. INFILL ALL GAPS BETWEEN STONES WITH GROWING MEDIUM 2. BOULDER SIZE: MIN. 300 X 300MM SHAPE: NATURAL ROUNDED PLACEMENT: TIGHT FITTING, SMALL GAPS, SECURE FIT (NO MOBILITY) 3. FROM ONSITE STORAGE 4. NO SPLIT FACES EXPOSED 5. CONSULTANT TO OVERSEE STONE PLACEMENT ON SITE

THE CONSERVATORY UBC LOT 5 WESTBROOK PLACE

ADDRESS 5608 Berton Avenue, Vancouver BC

PROJECT

DETAILS


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DRAWING				-

NOTES:

- 1. PLANT TO BE PLANTED WITH TOP OF ROOTBALL LEVEL WITH FINISH GRADE OF GROWING MEDIUM.
- 2. COMPOSTED BARK MULCH AT 2" DEPTH TO BE KEPT AT LEAST 2" AWAY FROM STEMS. 3. PRUNE ANY BROKEN OR DAMAGED BRANCHES AND DOUBLE LEADERS USING APPROVED PRUNING
- TOOLS AND STANDARD I.S.A. PRUNING PRACTICES, SEE SPECIFICATIONS.



-FINISH GRADE GROWING MEDIUM -FINISH GRADE MULCH

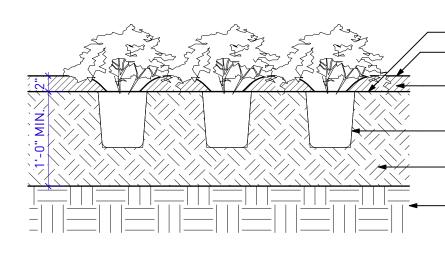-MULCH


ENSURE FULL CONTACT BETWEEN ROOTBALL AND PLANTING MEDIUM GROWING MEDIUM

COMPACTED SUBGRADE

GROUNDCOVER PLANTING ON GRADE Scale: 1" = 1'-0"

NOTES:


- 1. PLANT TO BE PLANTED WITH TOP OF ROOTBALL LEVEL WITH FINISH GRADE.
- 2. COMPOSTED BARK MULCH TO BE KEPT AT LEAST 2" AWAY FROM STEMS. 3. PRUNE ANY BROKEN OR DAMAGED BRANCHES AND DOUBLE LEADERS USING APPROVED PRUNING TOOLS AND STANDARD I.S.A. PRUNING PRACTICES, SEE SPECIFICATIONS.

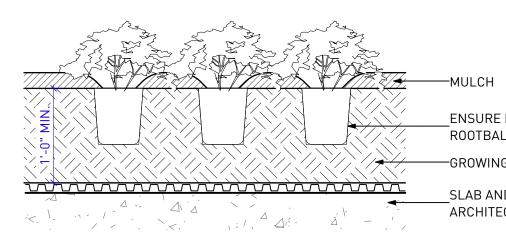



ENSURE FULL CONTACT BETWEEN ROOTBALL AND PLANTING MEDIUM -GROWING MEDIUM

SLAB AND BUILDUP - REFER TO ARCHITECTURAL DRAWINGS



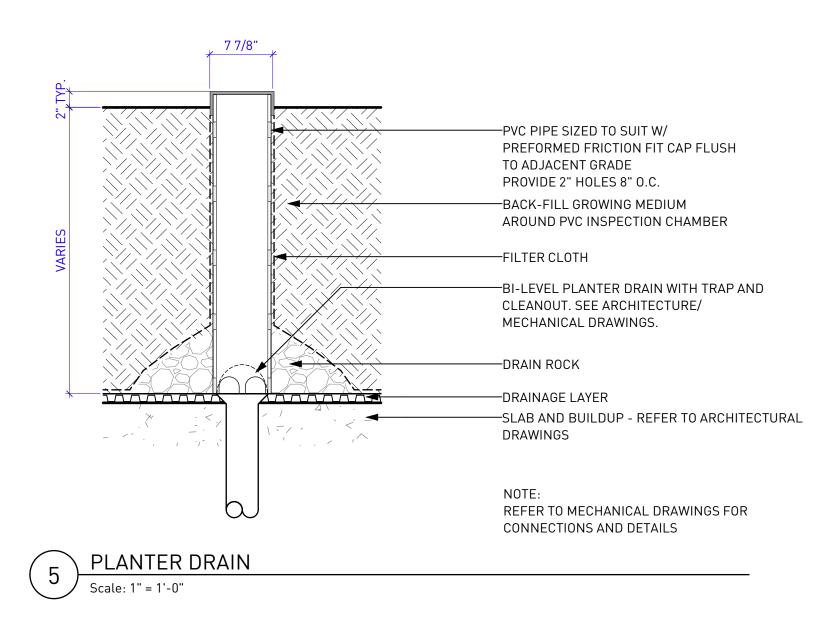

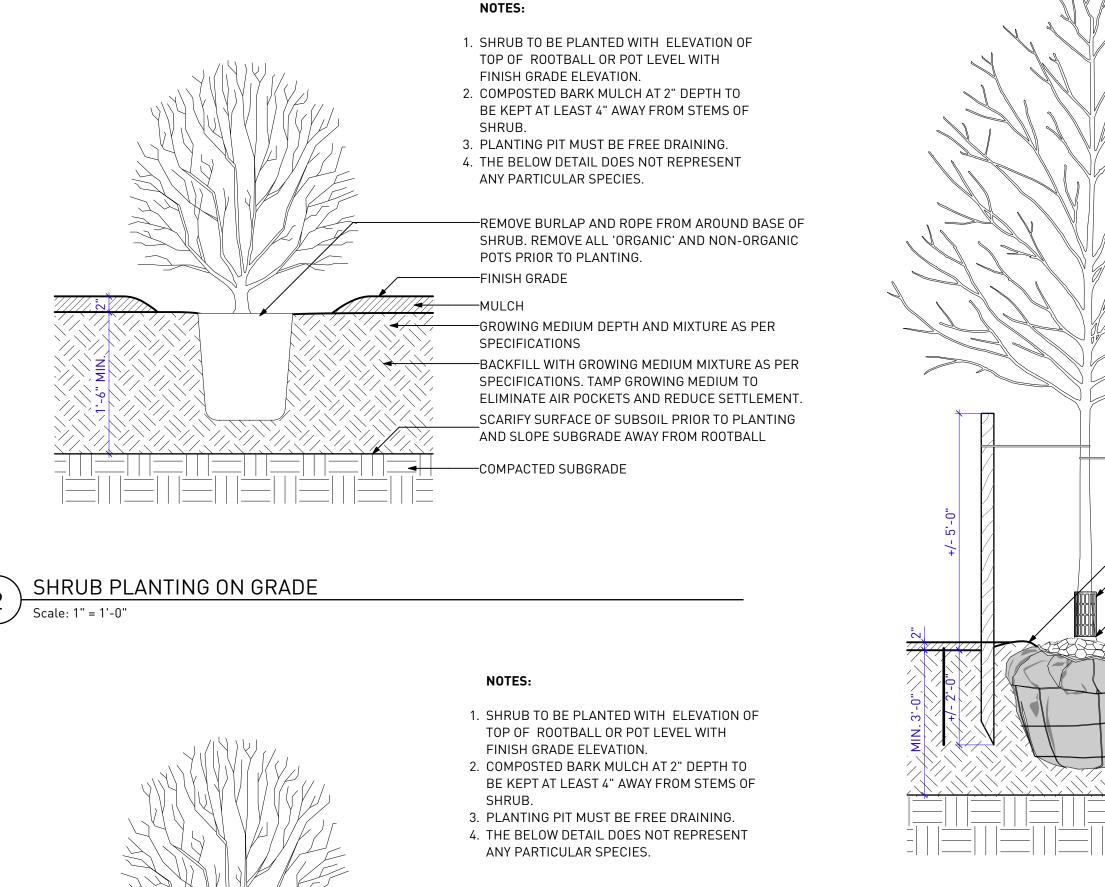

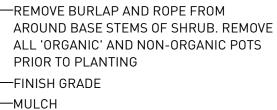


-GROWING MEDIUM DEPTH AND MIXTURE AS PER SPECIFICATIONS

-BACKFILL WITH GROWING MEDIUM MIXTURE AS PER SPECIFICATIONS. TAMP GROWING MEDIUM TO ELIMINATE AIR POCKETS AND REDUCE SETTLEMENT.

SLAB AND BUILDUP - REFER TO ARCHITECTURAL DRAWINGS

SHRUB PLANTING ON SLAB / Scale: 1" = 1'-0"

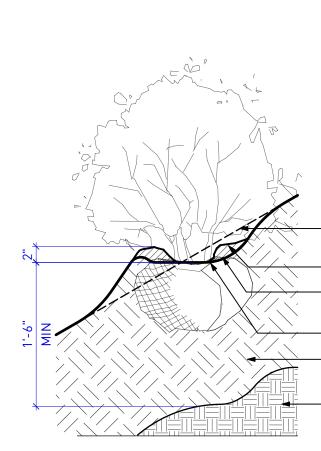

SHRUB PLANTING ON SLOPE

Scale: 1" = 1'-0"

NOTES:


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- 1. SHRUB TO BE PLANTED WITH TOP OF ROOTBALL LEVEL WITH FINISH GRADE.
- 2. COMPOSTED BARK MULCH TO BE KEPT AT LEAST 50mm AWAY FROM STEMS. 3. PRUNE ANY BROKEN OR DAMAGED
- BRANCHES USING APPROVED PRUNING TOOLS AND STANDARD I.S.A. PRUNING PRACTICES, SEE SPECIFICATIONS.

-LINE OF SLOPE TO BE REGRADED AS SHOWN -MULCH

-TOP OF ROOTBALL LEVEL WITH FINISH GRADE

-DISH SOIL TO HOLD WATER -GROWING MEDIUM AS PER SPECIFICATIONS

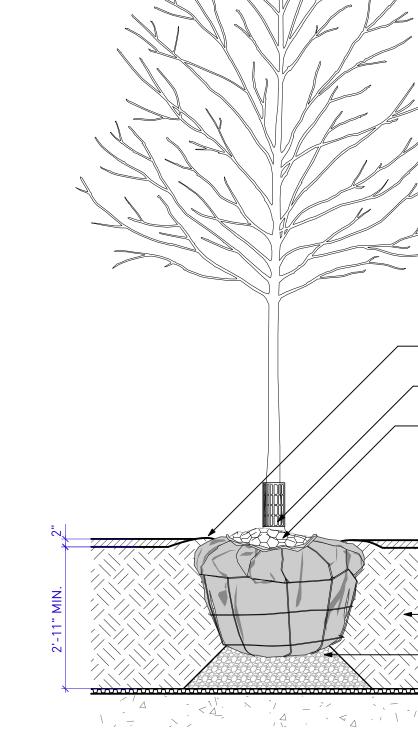

TREE PLANTING ON GRADE

NIV

Scale: 1/2" = 1'-0"

TREE PLANTING ON SLAB



			X.
NOTES:			PWL partnership
 TREE TO BE PLANTED WITH ELEVATI OF TOP OF ROOTBALL LEVEL WITH FINISH GRADE ELEVATION. TRUNK FLARE MUST BE VISIBLE AFTER PLANTING. COMPOSTED BARK MULCH TO BE KE AT LEAST 4" AWAY FROM BASE OF TREE TRUNK ALL SIDES. ONLY PRUNE BROKEN OR DAMAGED BRANCHES USING APPROVED PRUNING TOOLS AND STANDARD I.S PRUNING PRACTICES AS DIRECTED 	EPT) 5.A.		PWL Partnership Landscape Architects Inc Sth Floor, East Asiatic House 1201 West Pender Street Vancouver BC Canada V6E 2V2 www.pwlpartnership.com T 604.688.6111 F 604.688.6112
CONSULTANT OR PROJECT ARBORIS SEE SPECIFICATIONS. 4. PLANTING PIT MUST BE FREE DRAINING.	Τ.		
 5. ROOT BARRIER TO BE PROVIDED FOR TREES WITHIN 6'0" OF A PAVED SURFACE. ROOT BARRIER TO TO BE 2'0" DEEP AND EXTEND FOR 6'0" EACH WAY FROM CENTER OF TREE. 6. CONTRACTOR TO DIG ONE SAMPLE TREE PIT FOR CONSULTANT REVIEW PRIOR TO FILLING WITH GROWING MEDIUM. 		260 - 177	S architecture 0 Burrard Street Vancouver BC V6J 3G7 69 7710 www.dysarchitecture.com
ARBOR TIE FROM DEEPROOT OR APP	PROVED EQUAL		东北
DISH GROWING MEDIUM TO HOLD W	ATER, AS DIRECTED		
ARBORGARD, SEE SPECIFICATIONS QTY. 2 - 80mm DIAMETER TIMBER ST REQUIRED ONLY IF TREE IS UNSTABL STAKE TO AVOID PENETRATING INTO STAKE TO BE REMOVED AFTER TWO	LE 0 ROOTBALL	PC	OLYGON
REMOVE BURLAP AND ROPE FROM AROUND BASE OF TRUNK FINISH GRADE MULCH BACKFILL WITH GROWING MEDIUM I SPECIFICATIONS. TAMP GROWING MEDIUM TO ELIMIN/ AND REDUCE SETTLEMENT. ROOT BARRIER, AT SIDEWALK COND	ATE AIR POCKETS	NO. DATE 1 2020-03-01 2 2020-05-29 3 2020-07-16 5 2020-10-29 6 2021-01-08	DESCRIPTION ISSUED FOR PRICING ISSUED FOR 50% BUILDING PERMIT ISSUED FOR 90% BUILDING PERMIT ISSUED FOR TENDER ISSUED FOR BUILDING PERMIT
ENSURE 13mm ABOVE FINISH GRAD			
SCARIFY SURFACE OF SUBSOIL PRIO PLANTING AND SLOPE SUBGRADE A ROOTBALL	DR TO		
SUBGRADE			

NOTES:

- 1. TREE TO BE PLANTED WITH ELEVATION OF TOP OF ROOTBALL LEVEL WITH FINISH GRADE ELEVATION. TRUNK FLARE MUST BE VISIBLE AFTER PLANTING.
- 2. COMPOSTED BARK MULCH TO BE KEPT AT LEAST 4" AWAY FROM BASE OF
- TREE TRUNK ALL SIDES. 3. ONLY PRUNE BROKEN OR DAMAGED BRANCHES USING APPROVED PRUNING TOOLS AND STANDARD I.S.A. PRUNING PRACTICES AS DIRECTED BY CONSULTANT OR PROJECT ARBORIST. SEE SPECIFICATIONS.
- 4. PLANTING PIT MUST BE FREE DRAINING.

-DISH GROWING MEDIUM TO HOLD WATER,
AS DIRECTED
-ARBORGARD, SEE SPECIFICATIONS

-REMOVE BURLAP AND ROPE FROM AROUND BASE OF TRUNK -FINISH GRADE -MULCH

BACKFILL WITH GROWING MEDIUM MIXTURE AS PER SPECIFICATIONS. TAMP GROWING MEDIUM TO ELIMINATE AIR POCKETS AND REDUCE SETTLEMENT. -GROWING MEDIUM DEPTH AS PER SPECIFICATIONS -CRUSHED GRANULAR BASE

-SLAB AND BUILDUP - REFER TO ARCHITECTURAL DRAWINGS


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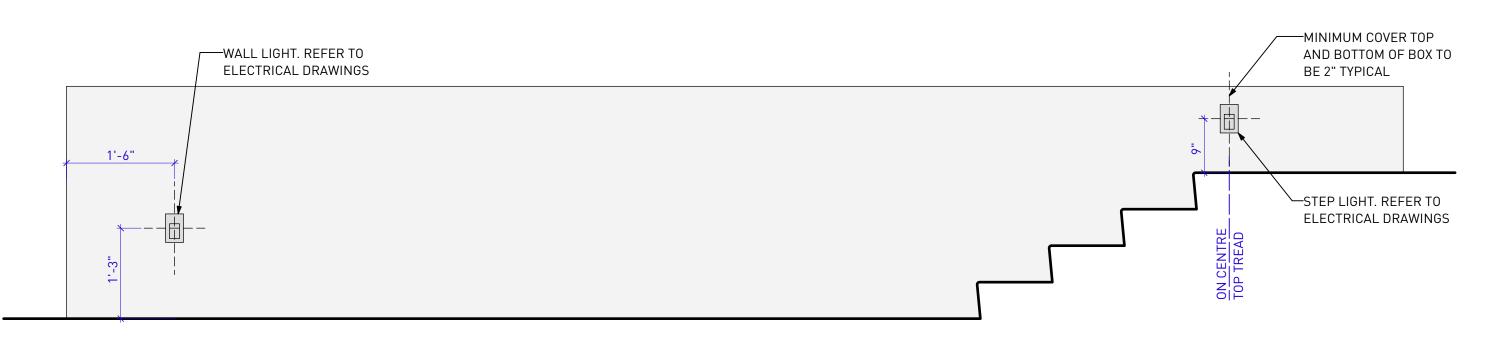
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DRAWING			



ELEVATION D LIGHTING AT SOUTHERN STAIR @ PARKADE




ELEVATION E LIGHTING AT FRONT ENTRY STAIR

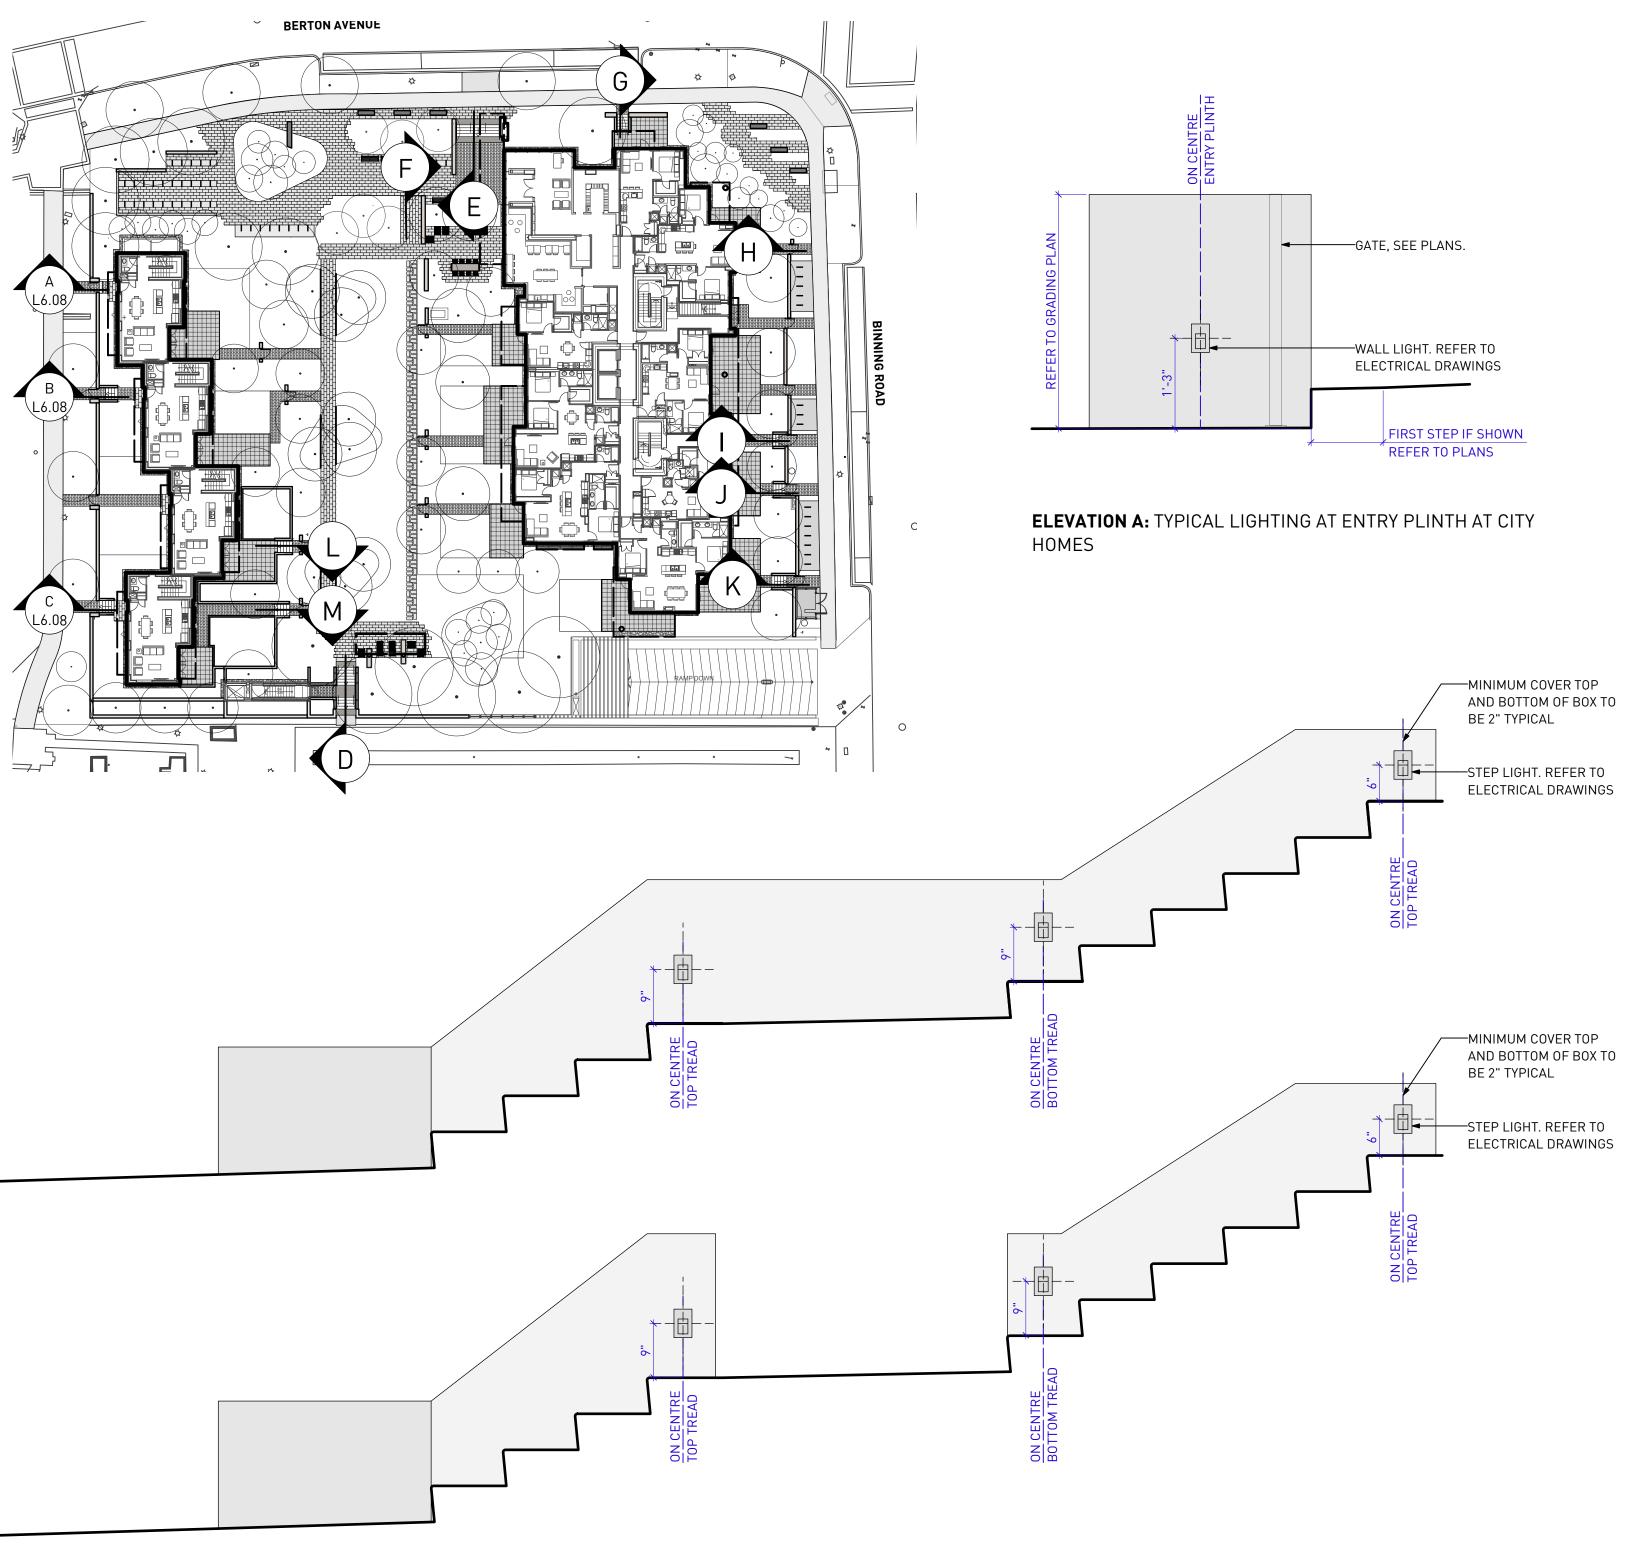
GATE, SEE PLANS.

ELEVATION B

— MINIMUM COVER TOP AND BOTTOM OF BOX TO BE 2" TYPICAL STEP LIGHT. REFER TO ELECTRICAL DRAWINGS

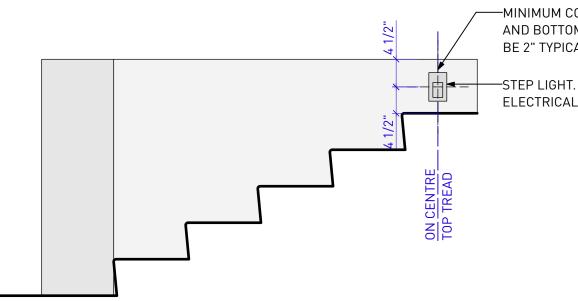

ELEVATION C

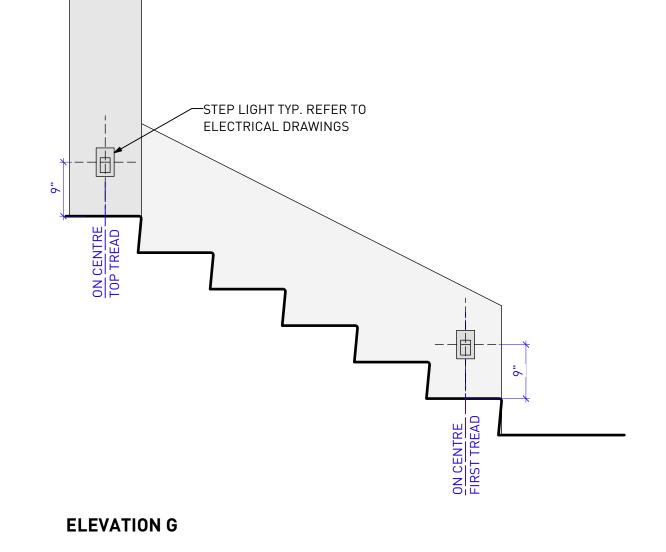

—MINIMUM COVER TOP AND BOTTOM OF BOX TO BE 2" TYPICAL

⊨ = ----STEP LIGHT. REFER TO ELECTRICAL DRAWINGS


PWL partnership

PWL Partnership Landscape Architects Inc 5th Floor, East Asiatic House 1201 West Pender Street Vancouver BC Canada V6E 2V2 www.pwlpartnership.com T 604.688.6111 F 604.688.6112





REVIS	REVISIONS AND ISSUES	
NO.	DATE	DESCRIPTION
1	2020-03-01	ISSUED FOR PRICING
2	2020-05-29	ISSUED FOR 50% BUILDING PERMIT
3	2020-07-16	ISSUED FOR 90% BUILDING PERMIT
5	2020-10-29	ISSUED FOR TENDER
6	2021-01-08	ISSUED FOR BUILDING PERMIT

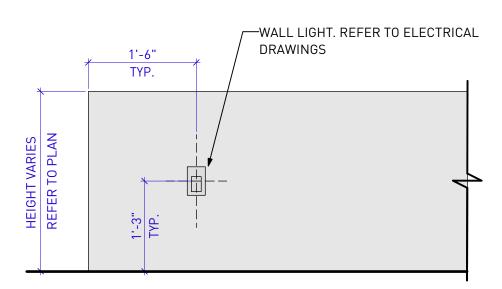

ELEVATION F: TYPICAL WALL LIGHT AT FEATURE WALL


PROJECT THE CONSERVATORY UBC LOT 5 WESTBROOK PLACE

ADDRESS 5608 Berton Avenue, Vancouver BC

DRAWING TITLE DETAILS


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NORTH		SCALE		
		As S	Shown	
PROJECT NO.	19037			
DATE	2019-05-1	0		
FILE NAME	19037 DET	AILS.vwx		
PLOTTED	2019-05-1	0		
DRAWN	MB	REVIEWED	BH	
DRAWING				




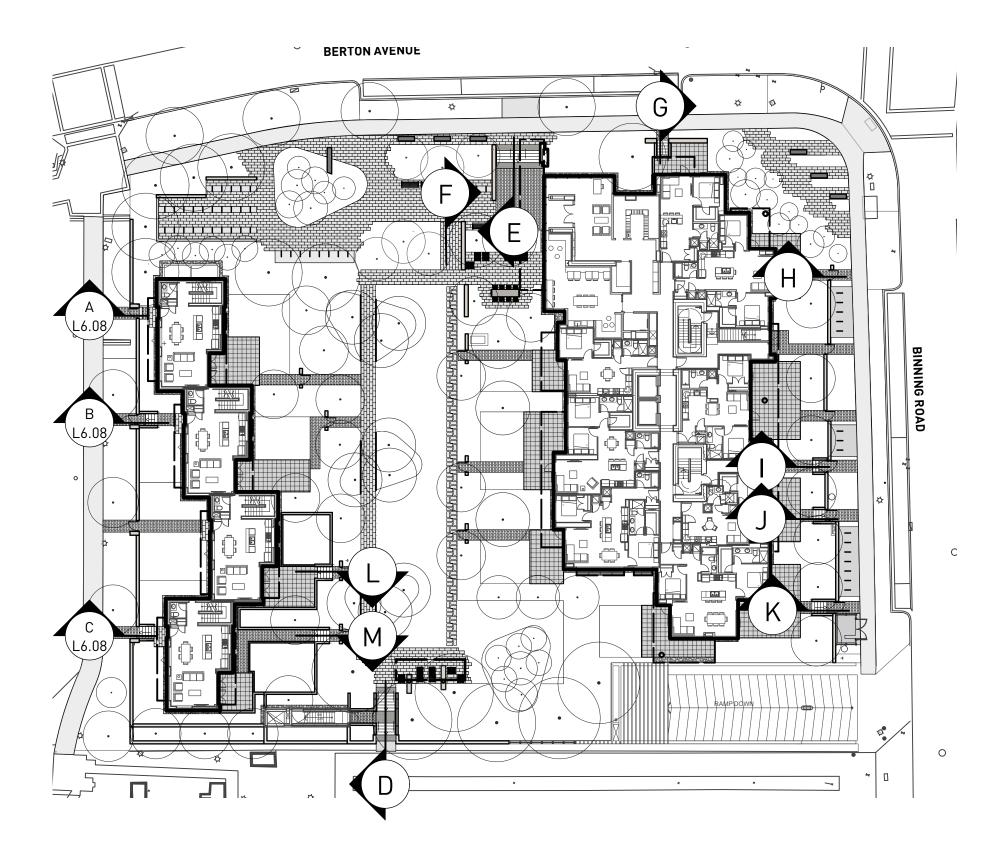


LANDSCAPE LIGHTING ELEVATIONS Scale: 3/4" = 1'-0"

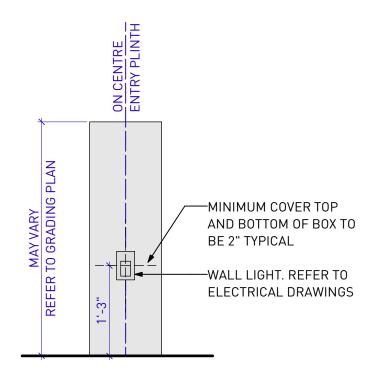


ELEVATION H: TYPICAL LIGHTING AT ENTRY PLINTH ON BINNING

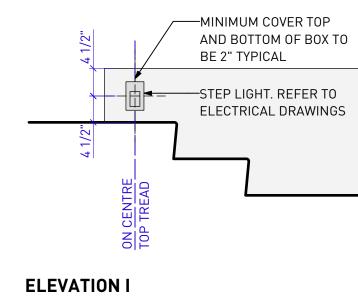

—MINIMUM COVER TOP AND BOTTOM OF BOX TO BE 2" TYPICAL GATE, SEE PLANS. ELECTRICAL DRAWINGS OP TREAD OF

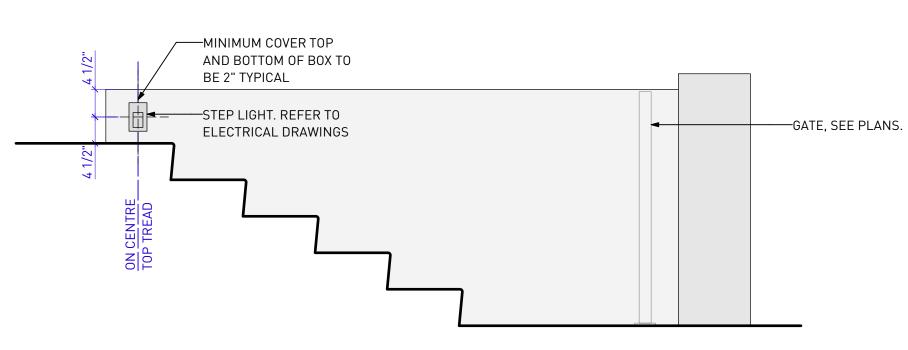

ELEVATION K

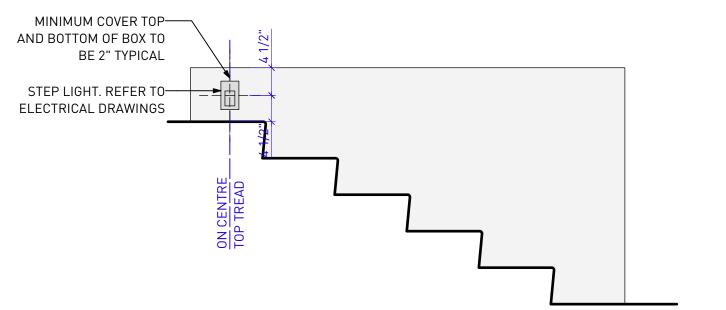

ELEVATION M

MINIMUM COVER TOP-

AND BOTTOM OF BOX TO BE 2" TYPICAL

ELEVATION L

ELEVATION J

PWL partnership


PWL Partnership Landscape Architects Inc 5th Floor, East Asiatic House 1201 West Pender Street Vancouver BC Canada V6E 2V2 www.pwlpartnership.com T 604.688.6111 F 604.688.6112





REVISIONS AND ISSUES				
NO.	DATE	DESCRIPTION		
1	2020-03-01	ISSUED FOR PRICING		
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5	2020-10-29	ISSUED FOR TENDER		
6	2021-01-08	ISSUED FOR BUILDING PERMIT		

PROJECT

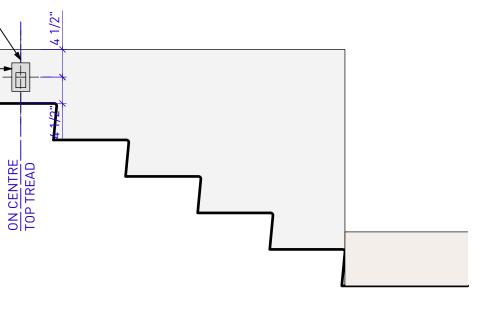

THE CONSERVATORY UBC LOT 5 WESTBROOK PLACE

ADDRESS 5608 Berton Avenue, Vancouver BC

DRAWING TITLE DETAILS

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NORTH		SCALE		
		As S	hown	
PROJECT NO.	19037			
DATE	2019-05-10			
FILE NAME	19037 DETAILS.vwx			
PLOTTED	2019-05-10			
DRAWN	MB	REVIEWED	ВН	
DRAWING				

POLYGON - THE CONSERVATORY ART PROPOSAL

SENTINELS

Our Sentinel sculptures were born from ~300 year old cedar trees that once stood on the same corner where they will be returned and re-erected in sculpture form. These monolithic watchkeepers are a testament to the omnipotence of the natural world. They will stand erect at the intersection of Binning and Berton, mirroring the majestic trees of Pacific Regional Park. Here they function as a gateway, providing a seamless transition between modern community and natural environment.

These pillars of cedar are carved with a curved face to accentuate their monumental scale. Each log is 12 ft tall, roughly 3ft diameter at the base, and will be stained black on the natural outer surface with a clear finish on the curved face. They will be mounted on steel platforms cut to the unique shape of each base and illuminated to produce a glowing halo effect at contact with the earth.



A: 48" x 48" B: 42" x 42" C: 50" x 56" D: 48" x 48" E: 52" x 48"

Illumination to give a similar effect as this work by Andy Goldsworthy.



BRENTCOMBER



THE CONSERVATORY ART PROPOSAL

B R E N T C O M B E R


4



THE CONSERVATORY ART PROPOSAL

B R E N T C O M B E R

5

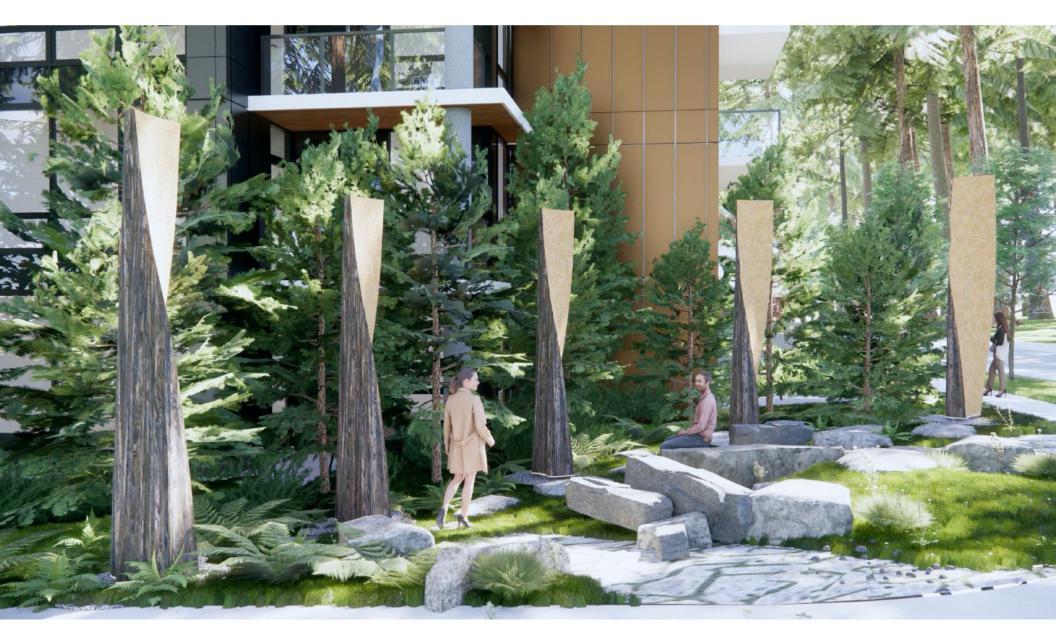

THE CONSERVATORY ART PROPOSAL

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